




SEÇÃO DE TERRAPLENAGEM
CORTE E ATERRO EM TANGENTE

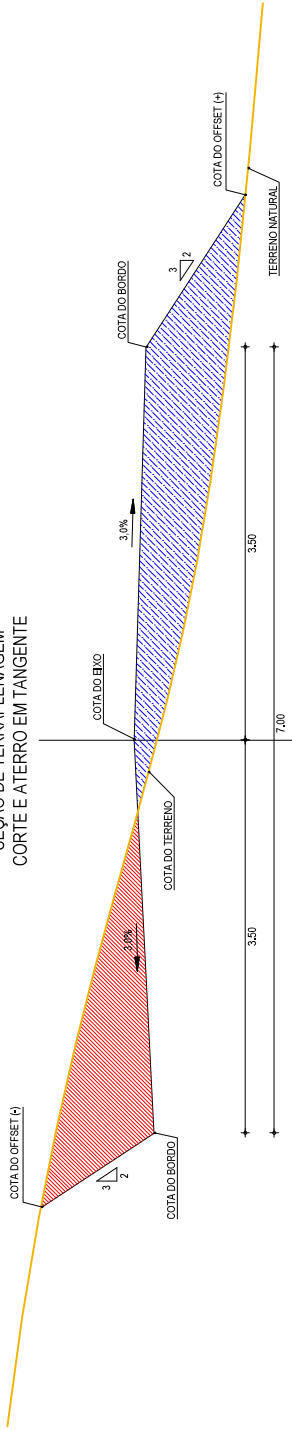

SEÇÃO DE TERRAPLENAGEM
CORTE E ATERRO EM CURVA

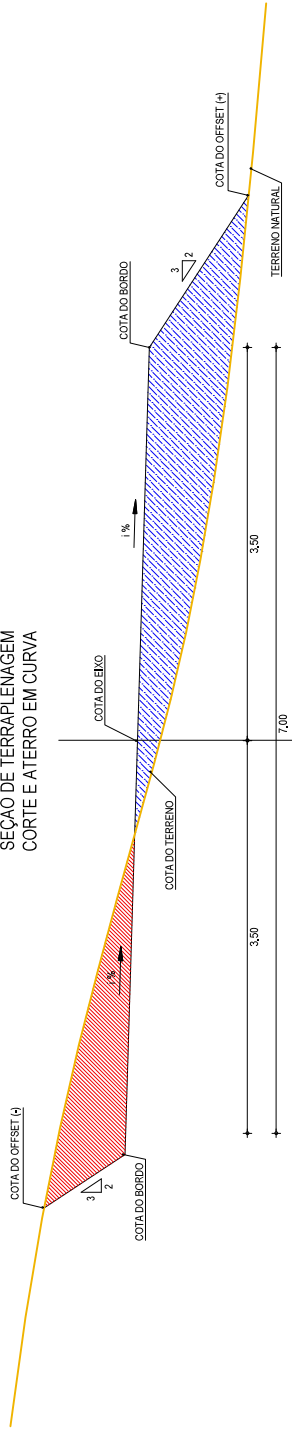

SEÇÃO DE TERRAPLENAGEM
ATERRO EM TANGENTE

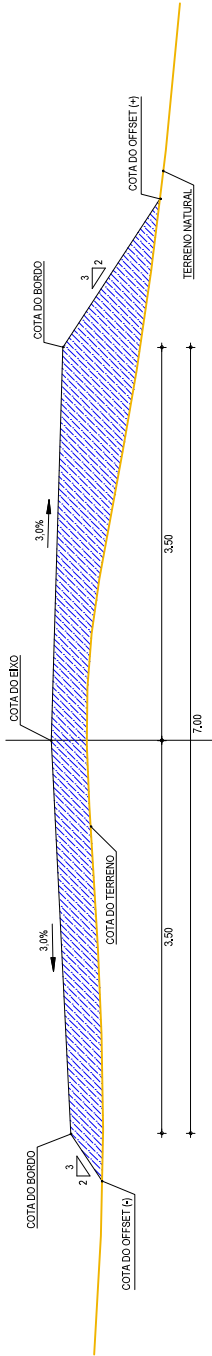

GEOPAC

AV. PADRE ANTÔNIO TOMAS, N.º 240, SALA 501
BARRIO ALDEIA FORTALEZA
FOFIE, 85.324.3147 EMAIL: GEOPAC@GEOPAC.COM.BR

01 SEÇÕES TIPO DE TERRAPLENAGEM

ESCALA: SEM ESCALA

ASSINATURAS E APROVAÇÃO

PROPRIETÁRIO:
PREFEITURA MUNICIPAL DE ARACATI

LEGENDA

- TERRENO NATURAL
- COTA GREIBE DE TERRAPLENAGEM
- ATERRO
- CORTE

PROJETISTA:

PROPRIETÁRIO:

PROJETO:
PAVIMENTAÇÃO NA LOCALIDADE DE JIRAU À PEIXOTO EM ARACATICE

CONTEÚDO:
PAVIMENTAÇÃO NA LOCALIDADE DE JIRAU À LOCALIDADE DE PEIXOTO

PROJETO TERRAPLENAGEM

IDENTIFICAÇÃO DOS DESENHOS:
01. SEÇÕES TIPO DE TERRAPLENAGEM

LEONARDO SILVEIRA LIMA
ENGENHEIRO CIVIL - RNP: 0901581087

APROVAÇÃO

LOCAL:
JIRAU - ARACATICE

DATA:
JULHO 2018

PRANCHAS:
38/48

DESENHO:
INDICADA

ESCALA:

CONTROLE:
ARCT 2018-41

DESCRIDA D'ÁGUA	
EXECUÇÃO	
ESCAVAÇÃO	-0,15 m ³
FERRO	-1,840 kg/m
FORMA	-1,188 m ²
CONCRETO (200 kg/m ³)	-0,063 m ³
CONSUMO DE SERRA D'ÁGUA	
DIAMETO	-0,300 m
ÁREA	-0,081 m ²
BRITA	-1,086 m ³
MADEIRA	-0,011 m ³
FERRO	-0,001 kg
CONSUMO ENTRADA D'ÁGUA	
DIAMETO	0,0055 m
ÁREA	0,0440 m ²
BRITA	0,0277 m ³
MADEIRA	0,0133 m ³
CONSUMO SERRA D'ÁGUA	
DIAMETO	0,0155 m
ÁREA	0,0733 m ²
BRITA	0,0255 m ³
PEDRA	0,2785 m ³
MADEIRA	0,0033 m ³

BANQUETA DE ATERRIO	
EXECUÇÃO	
ESCAVAÇÃO	0,015 m ³
CONCRETO (210 kg/m ³)	0,044 m ³
FORMA	0,300 m ²
CONSUMO	
CIMENTO	0,007 m
ÁREA	0,0234 m ²
BRITA	0,0420 m ³
MADEIRA	0,0034 m ³

SARJETAS TIPO I	
EXECUÇÃO	
ESCAVAÇÃO	0,115 m ³
CONCRETO (210 kg/m ³)	0,086 m ³
FORMA	0,250 m ²
CONSUMO	
CIMENTO	0,016 m
ÁREA	0,0758 m ²
BRITA	0,1248 m ³
MADEIRA	0,0038 m ³

NOTAS	
ASSIMETRIAS E APROVAÇÃO	
PROJEITISTA	PROF. FÉLIX
APROVAÇÃO	LEONARDO OLIVEIRA LIMA ENGENHEIRO CIVIL - RPPR 49189/07


































































































PREFEITURA MUNICIPAL DE ARACATI
 RAVIMENTAÇÃO NA LOCALIDADE DE JIRAU A REITO EM ARACATI
 CONTENDO:
 PAVIMENTAÇÃO NA LOCALIDADE DE JIRAU A LOCALIDADE DE PEIXOTO
 PROJETO DE DRENAGEM
 IDENTIFICADO DOS DESENHOS:
 01 - DETALHE ESCADA D'ÁGUA
 02 - DETALHE BANQUETA DE ATERRIO
 03 - DETALHE BANQUETA DE ATERRIO
 04 - DETALHE SARJETA DE CORTE TIPO "L"

ASSIMETRIAS E APROVAÇÃO
 PROJEITISTA: PROF. FÉLIX
 APROVAÇÃO: LEONARDO OLIVEIRA LIMA
 ENGENHEIRO CIVIL - RPPR 49189/07

GEO PAC
 GEOPAC
 RUA: AV. PRES. TANCREDO NEVES, S/N. 1.º ET. - JARDIM ALVARO (FONTECALDE)
 FONE: 33.24.3141 (FAX: 33.24.3141)

PREFEITURA MUNICIPAL DE ARACATI
 RAVIMENTAÇÃO NA LOCALIDADE DE JIRAU A REITO EM ARACATI
 CONTENDO:
 PAVIMENTAÇÃO NA LOCALIDADE DE JIRAU A LOCALIDADE DE PEIXOTO
 PROJETO DE DRENAGEM
 IDENTIFICADO DOS DESENHOS:
 01 - DETALHE ESCADA D'ÁGUA
 02 - DETALHE BANQUETA DE ATERRIO
 03 - DETALHE BANQUETA DE ATERRIO
 04 - DETALHE SARJETA DE CORTE TIPO "L"


TOTAL: 39-59/49
 DATA: JULHO/2018
 PROJETO: ARACATI
 INSCRIÇÃO: ARCT 2015-1

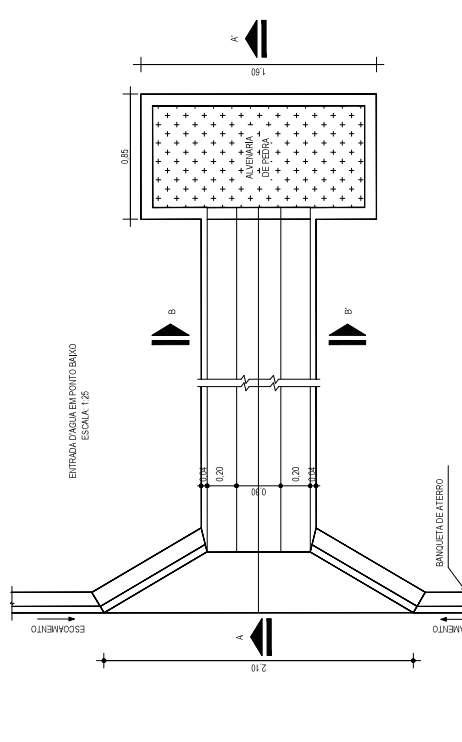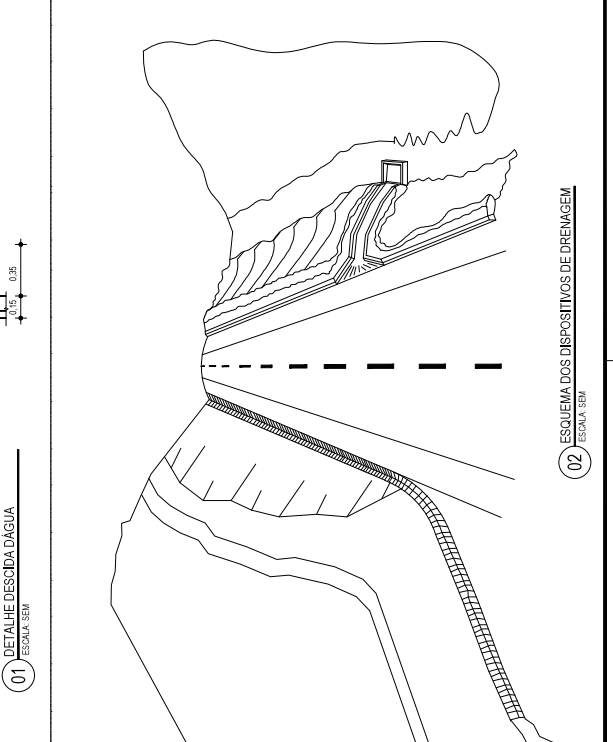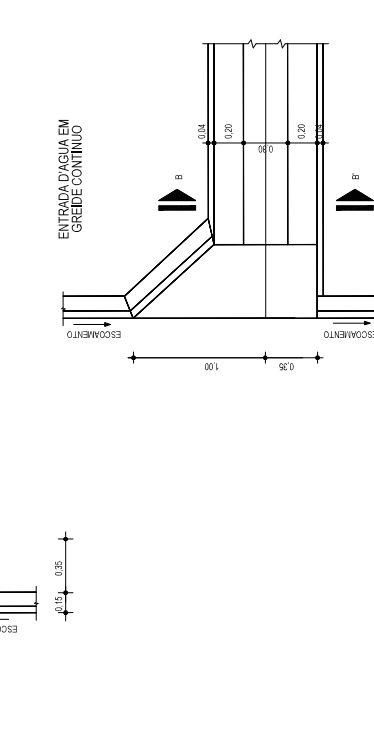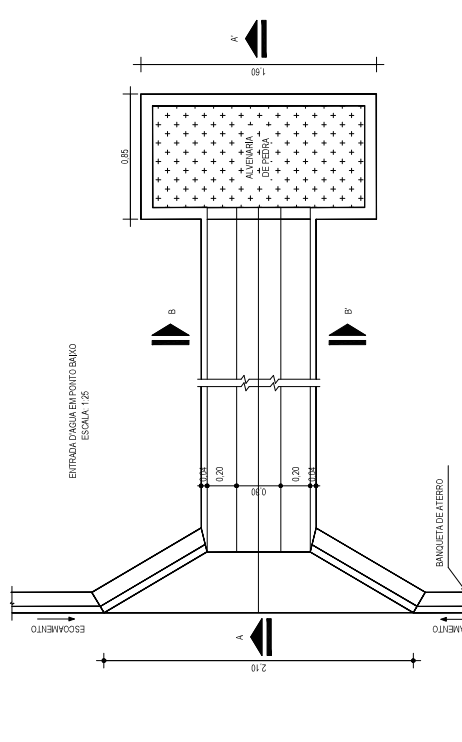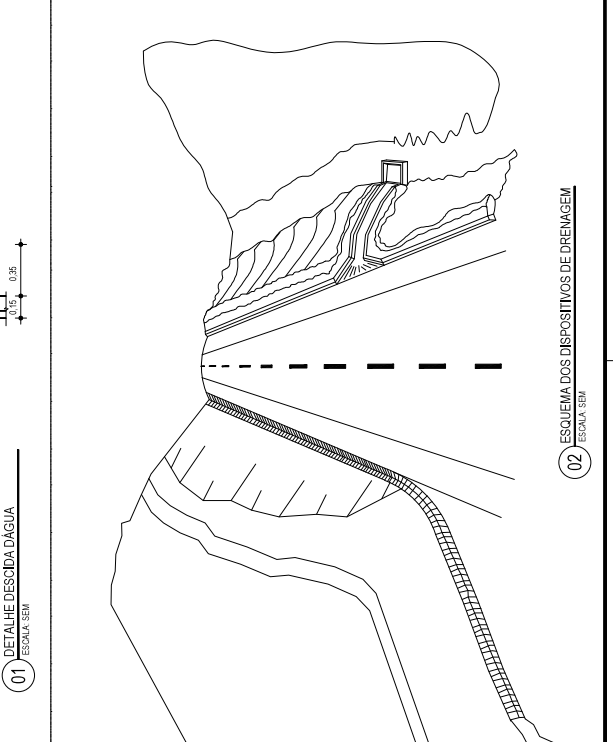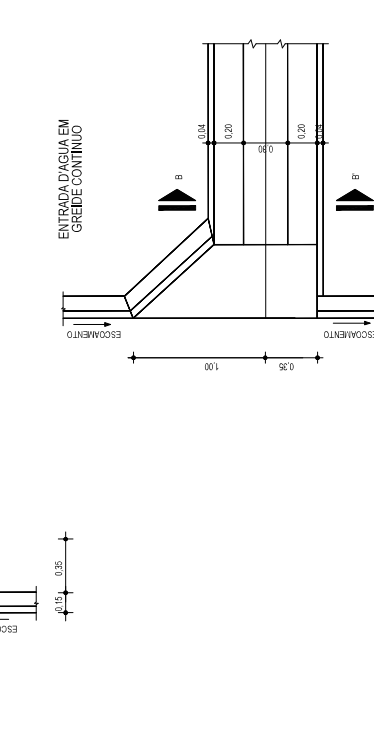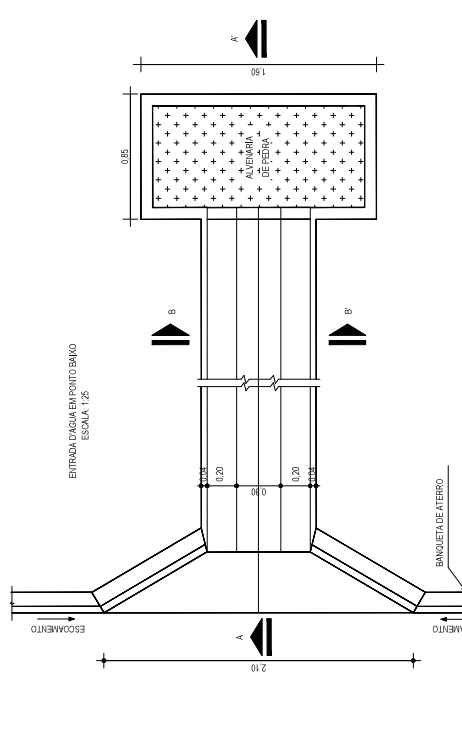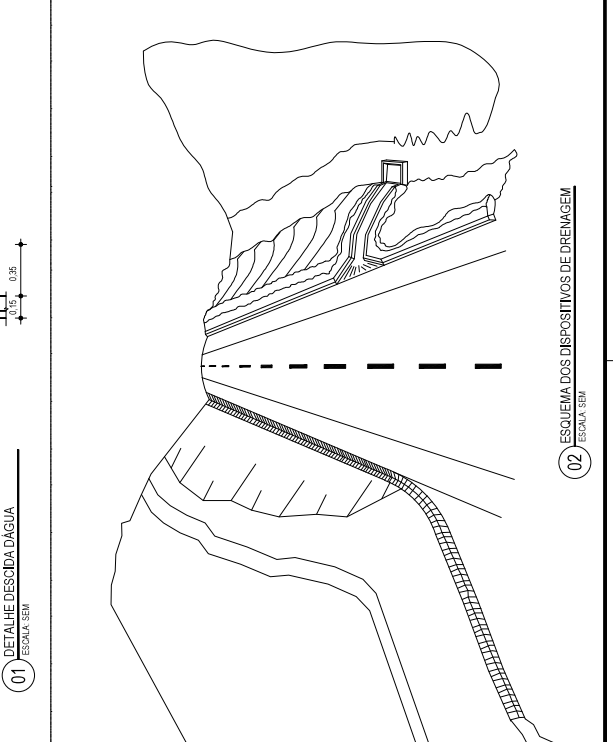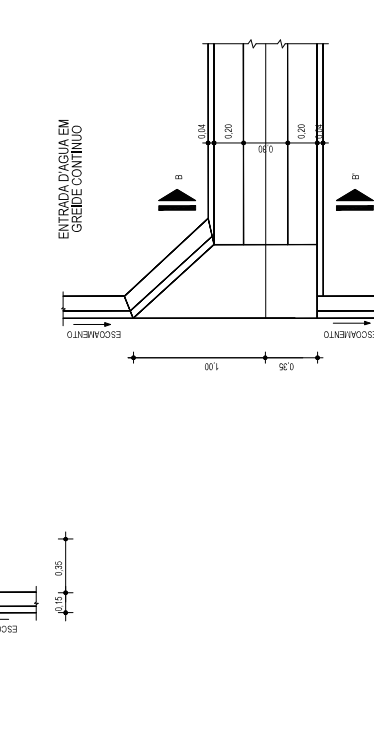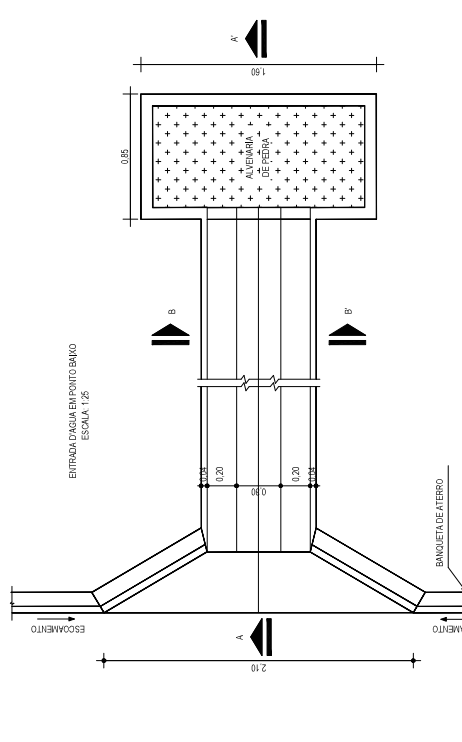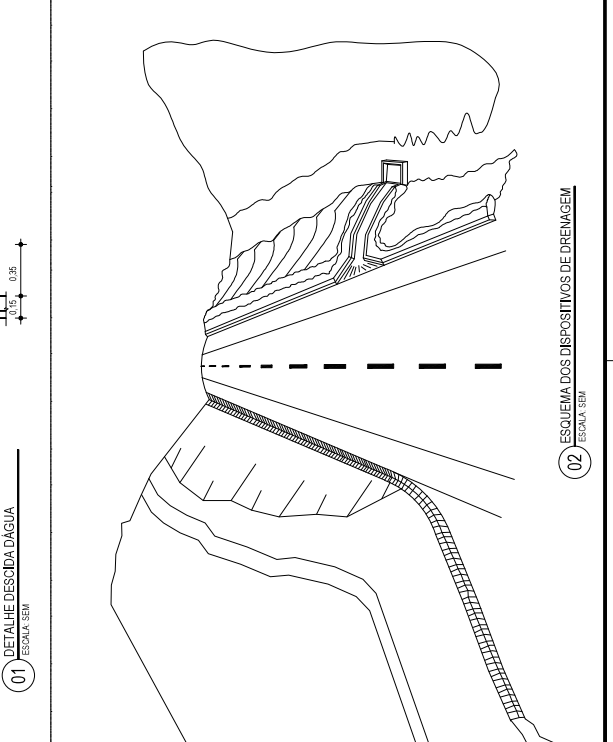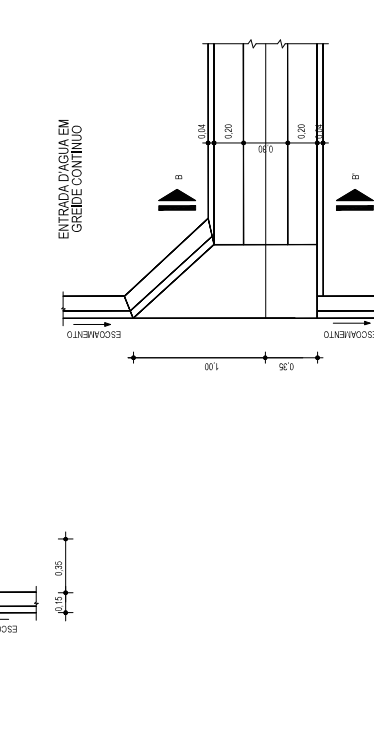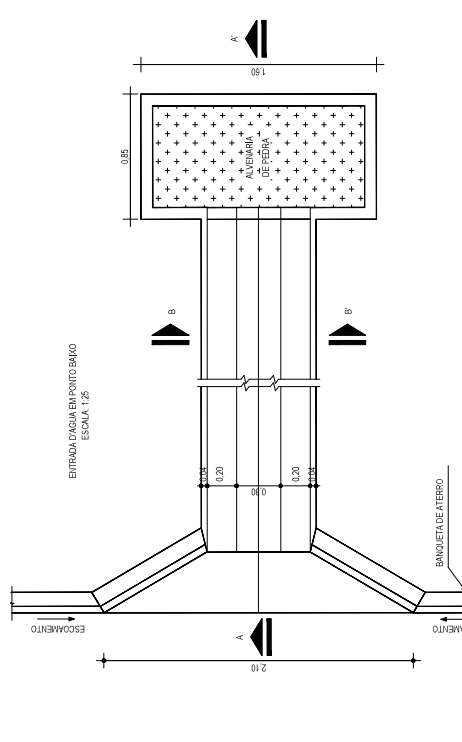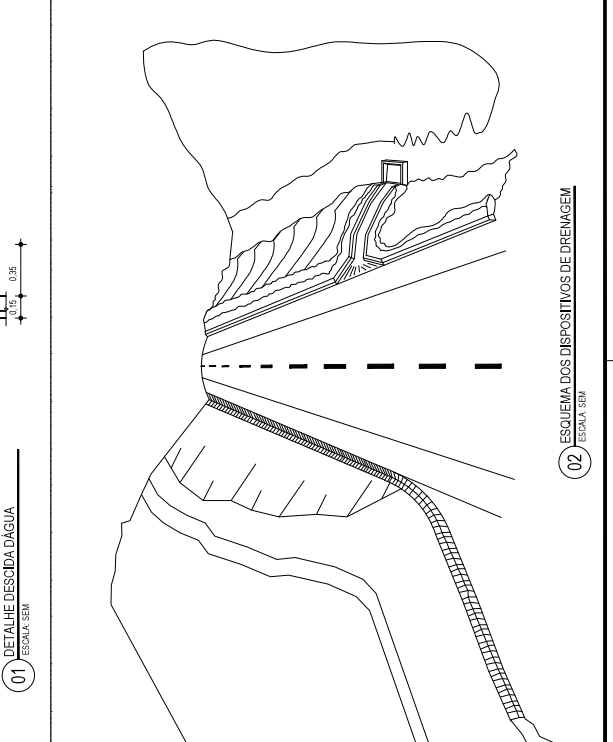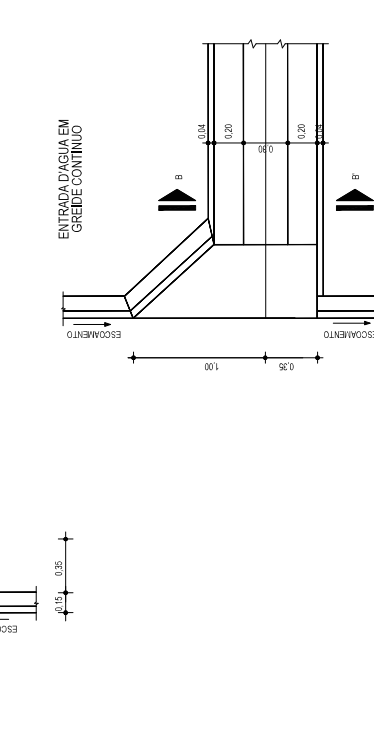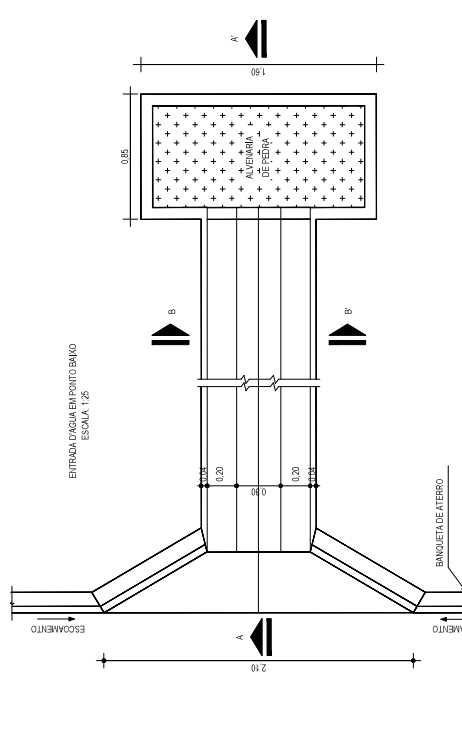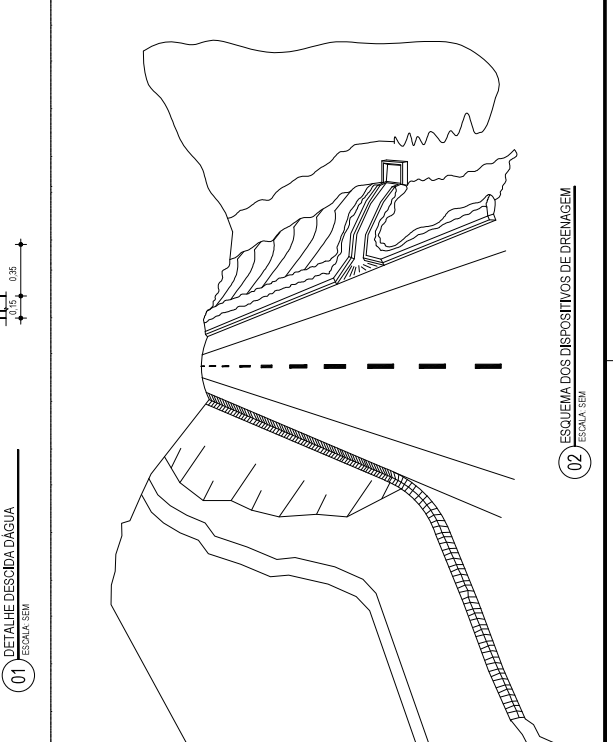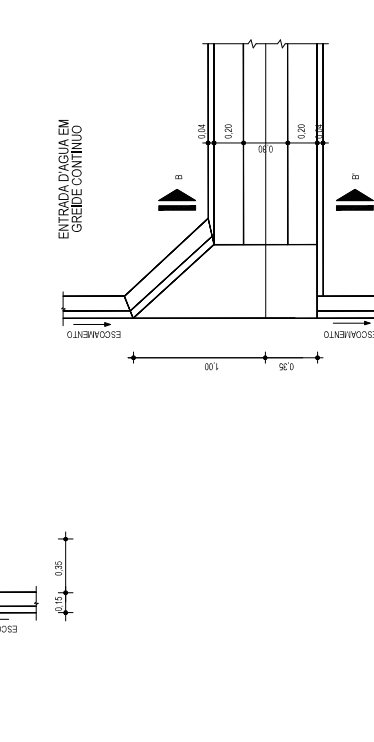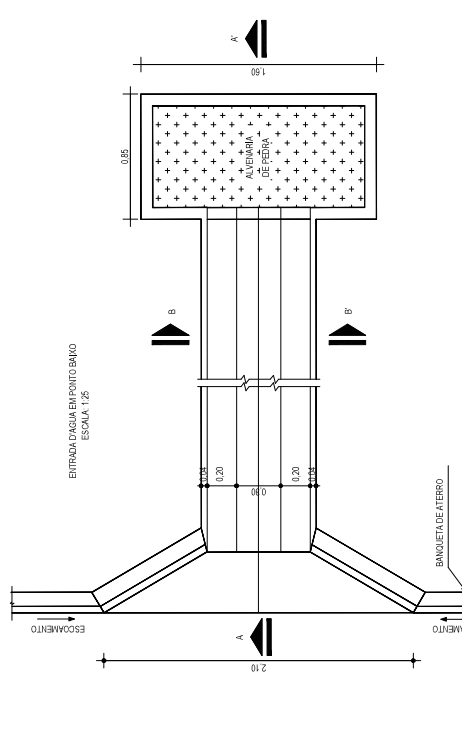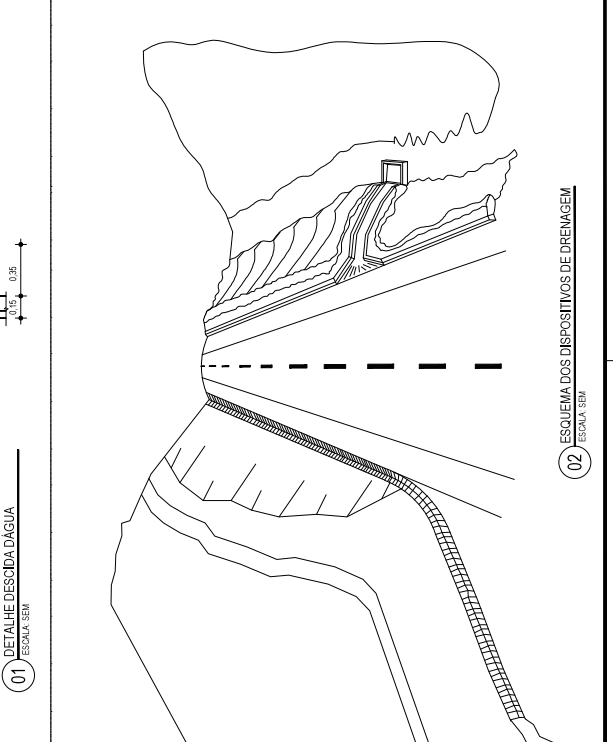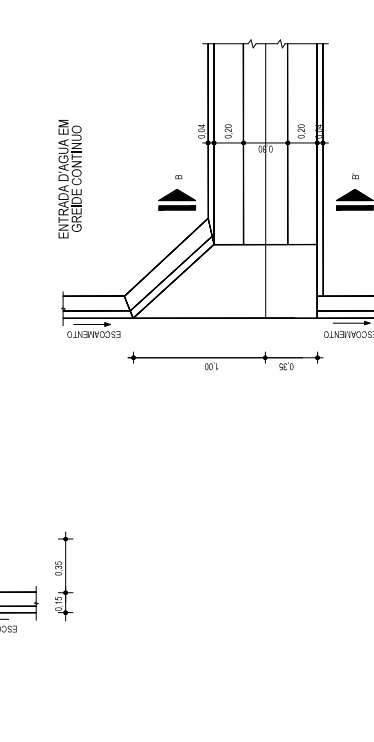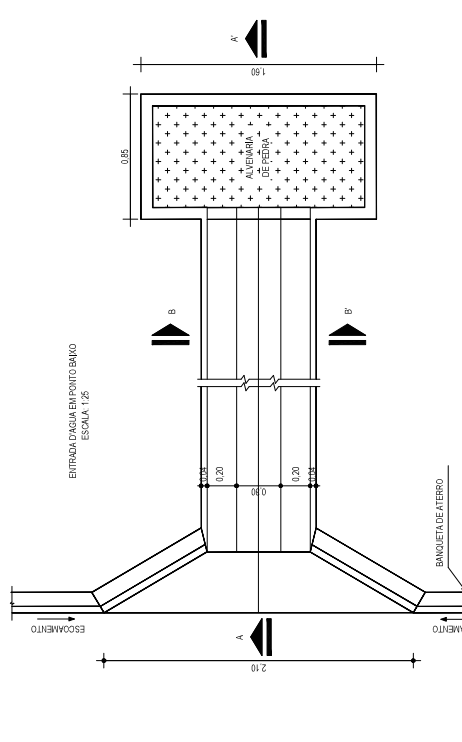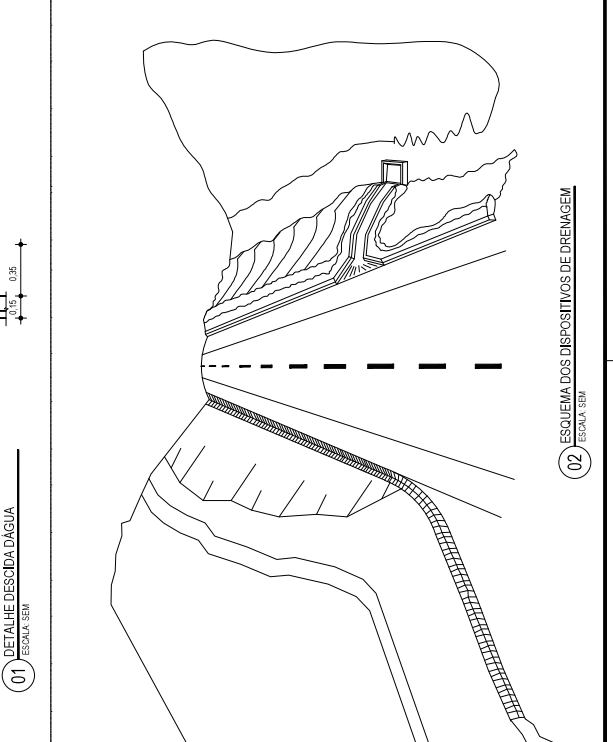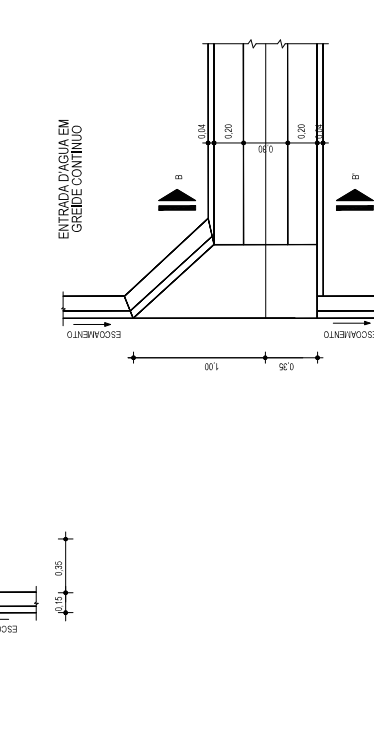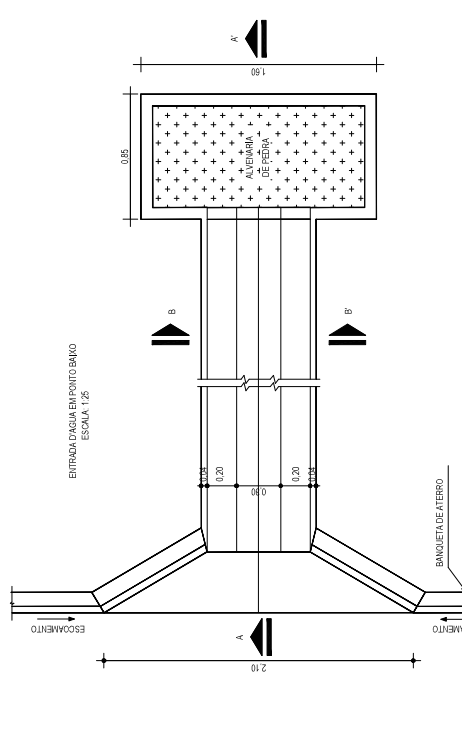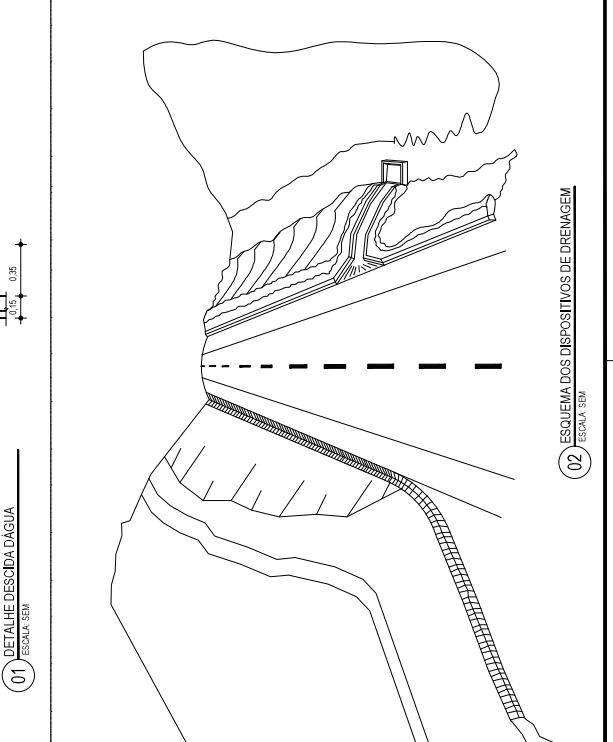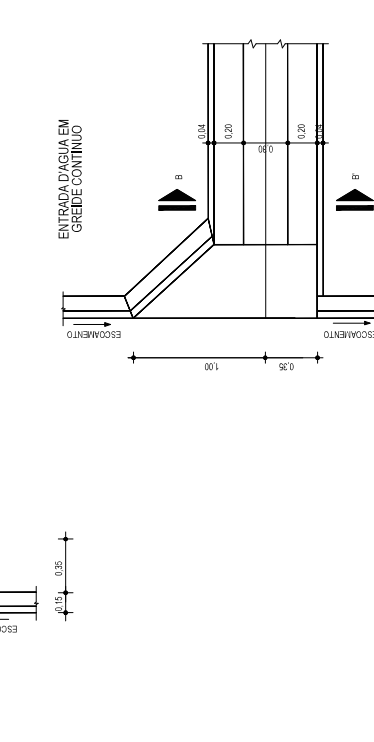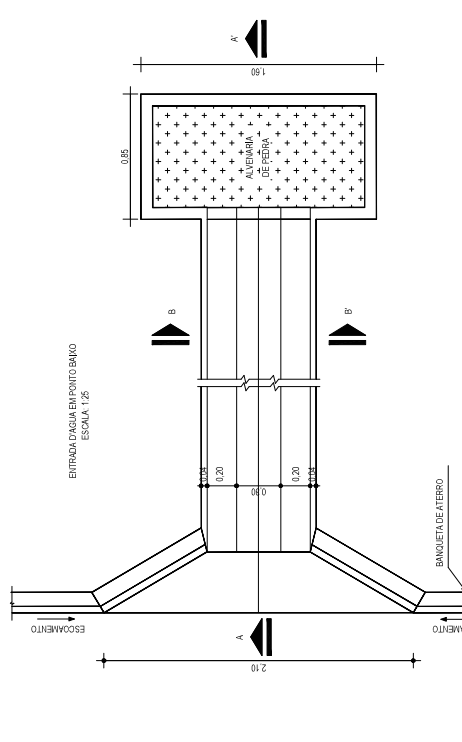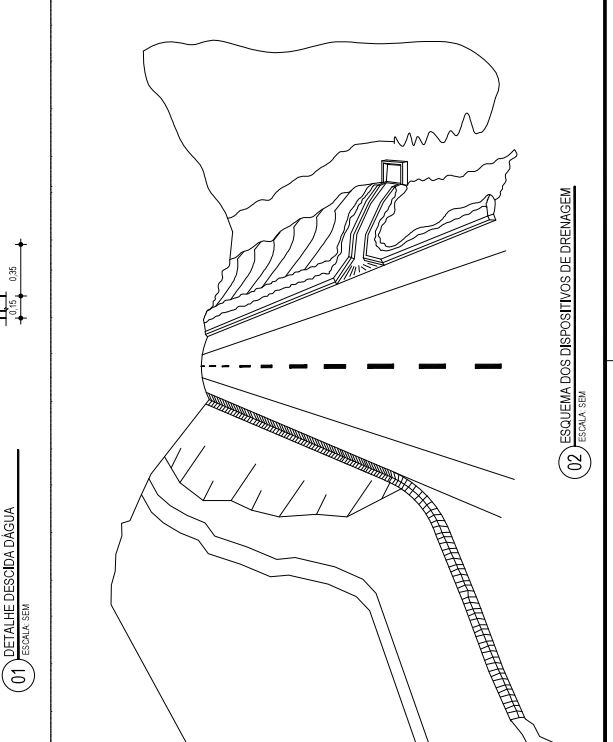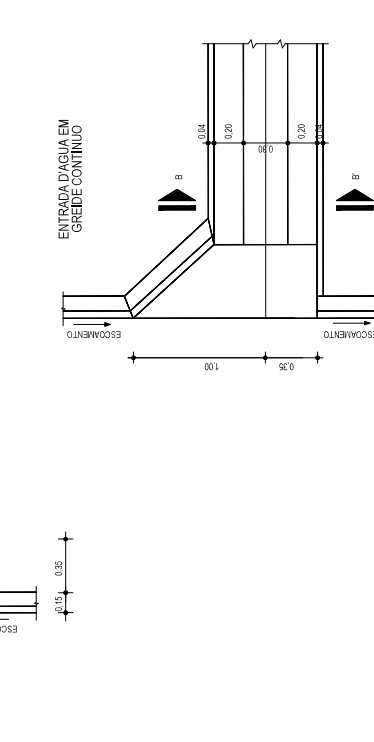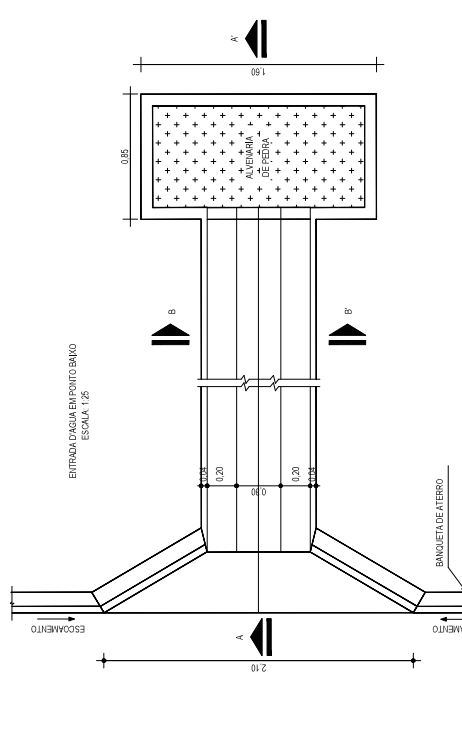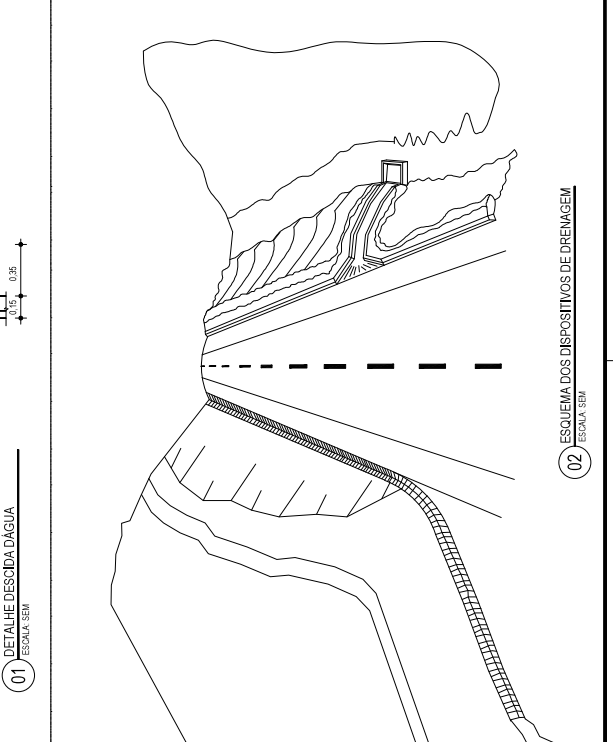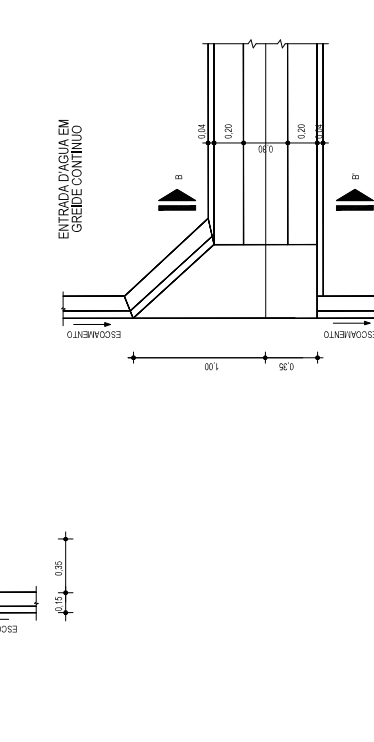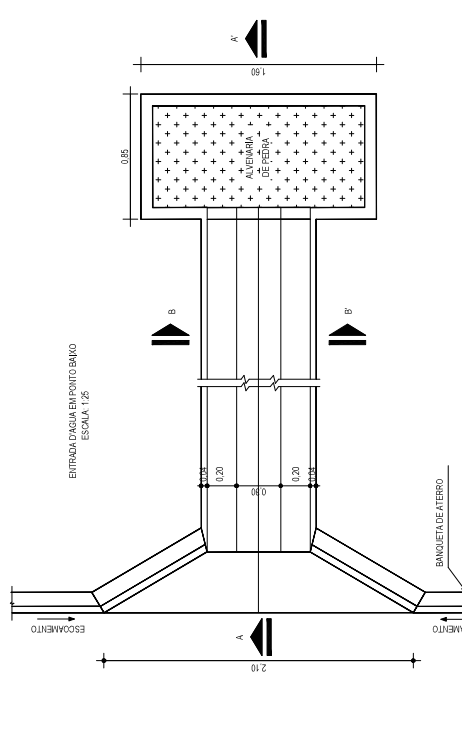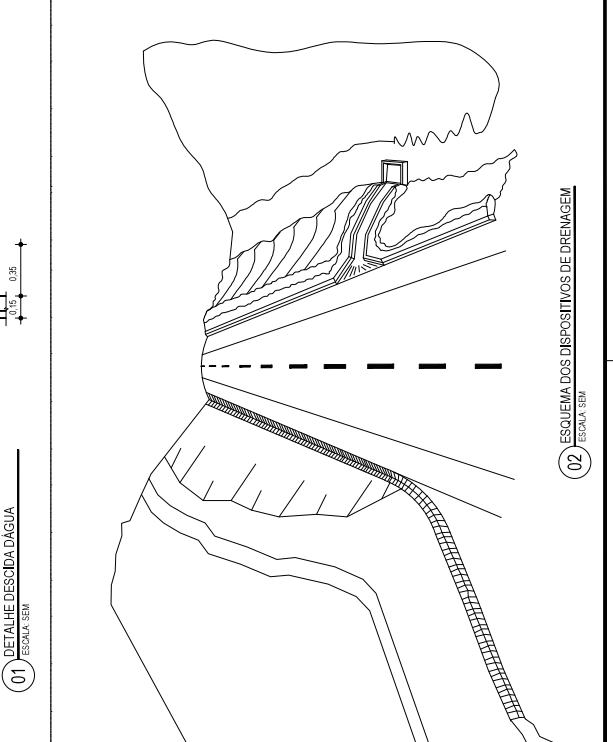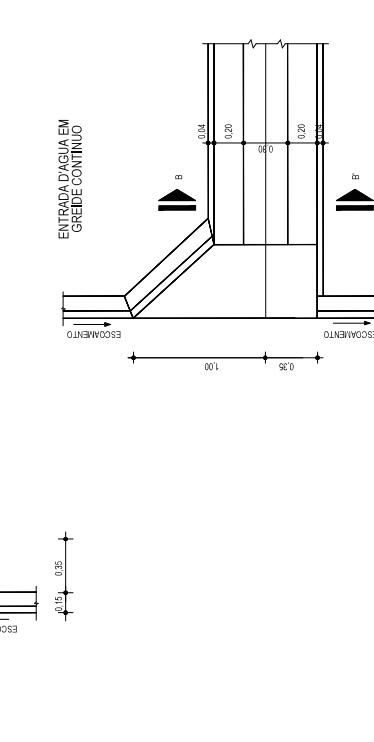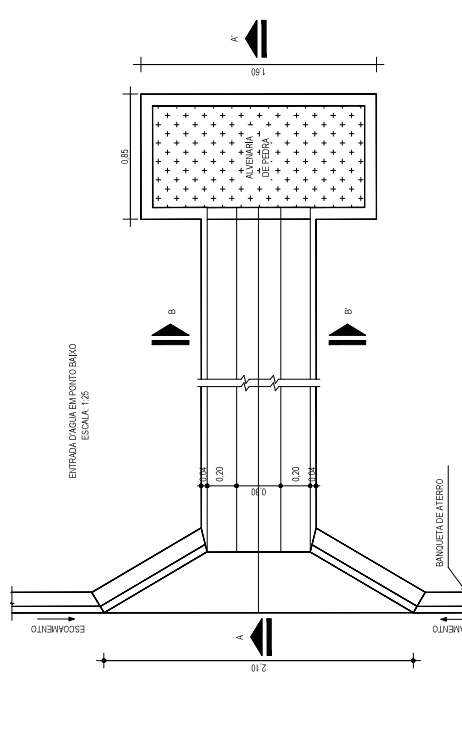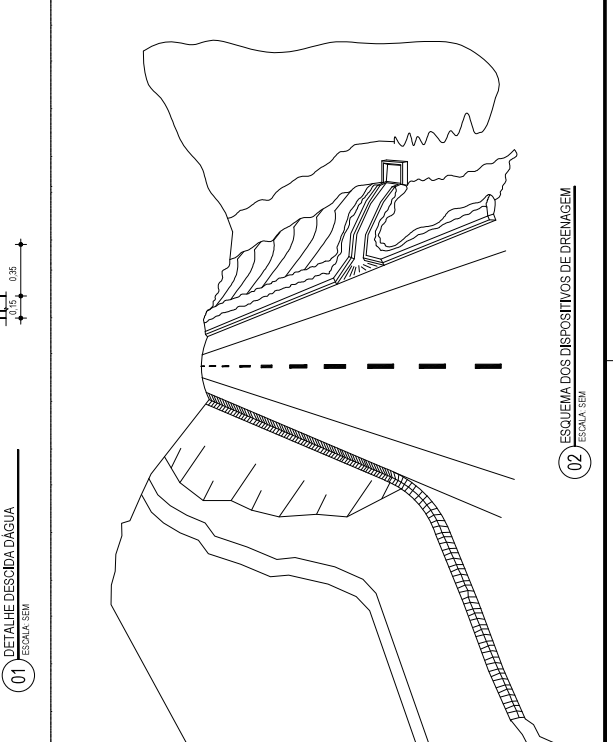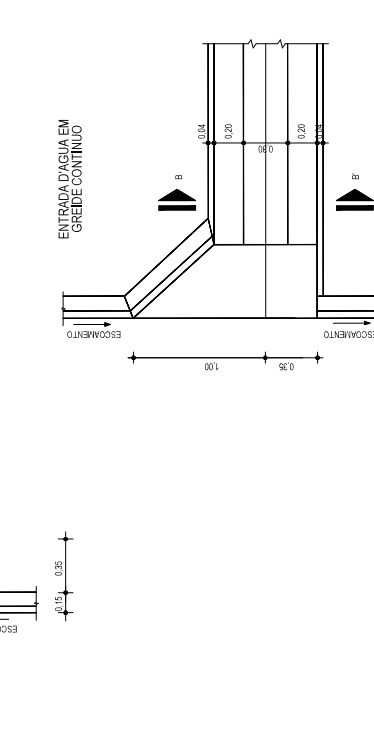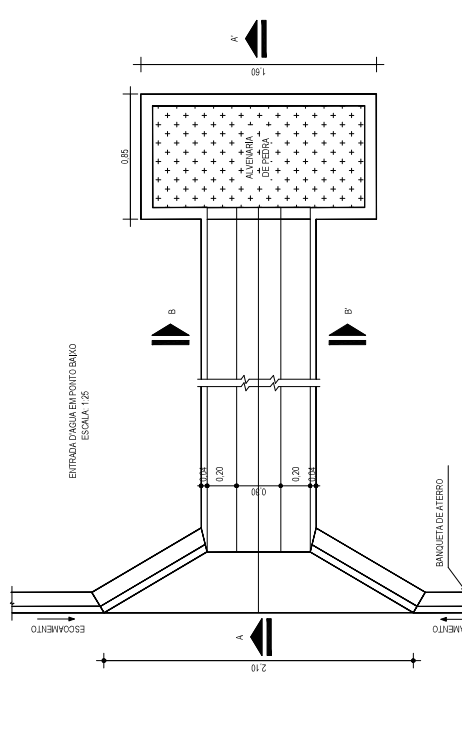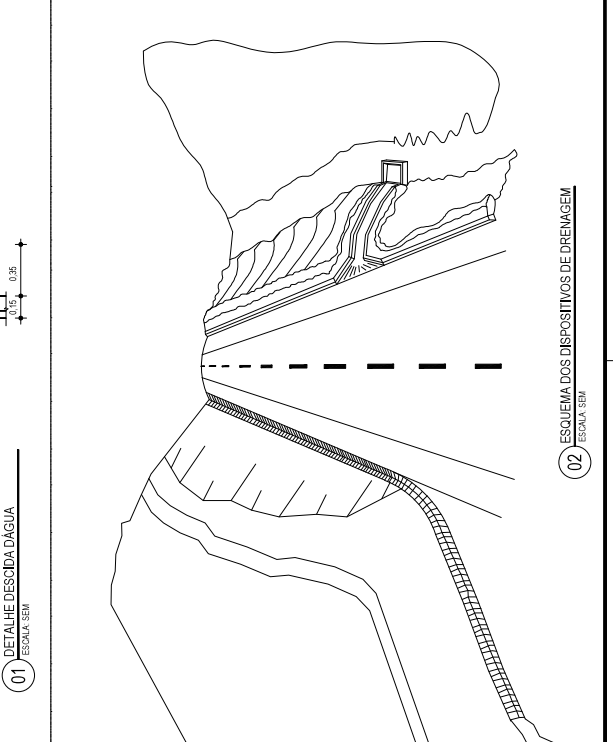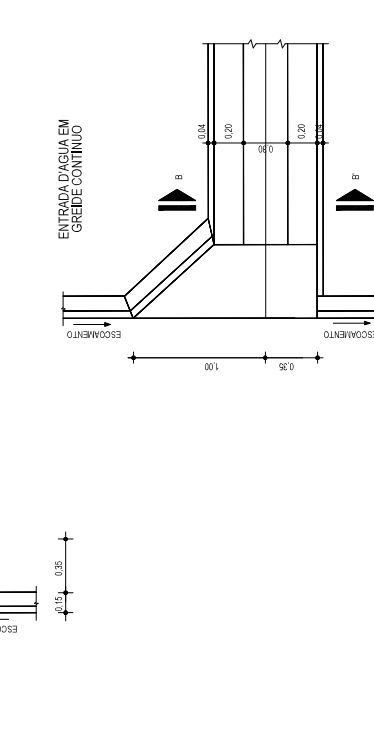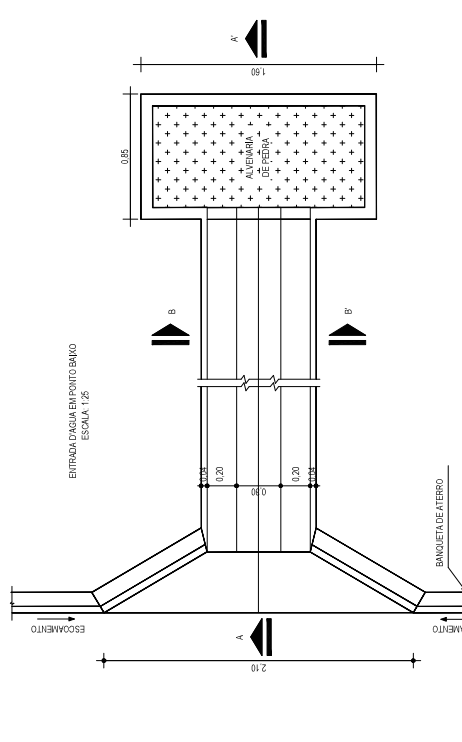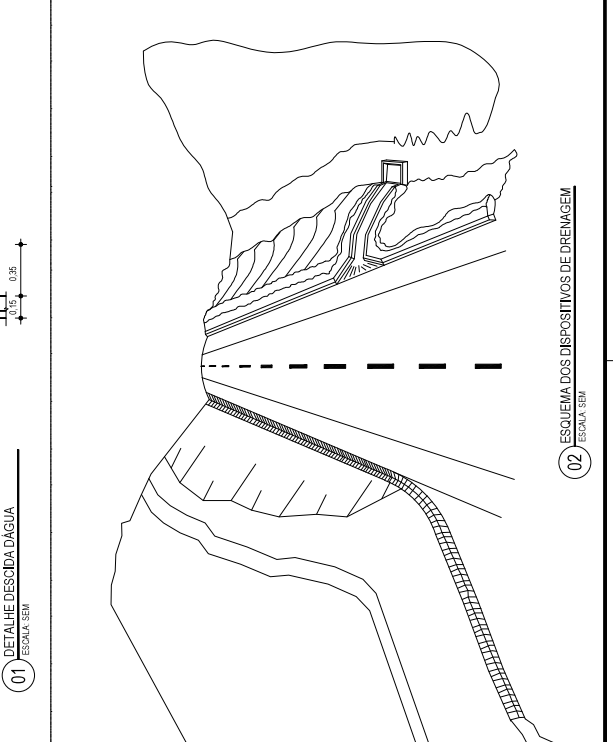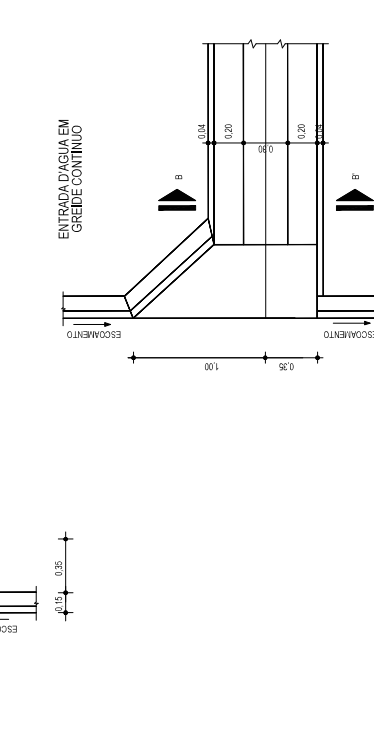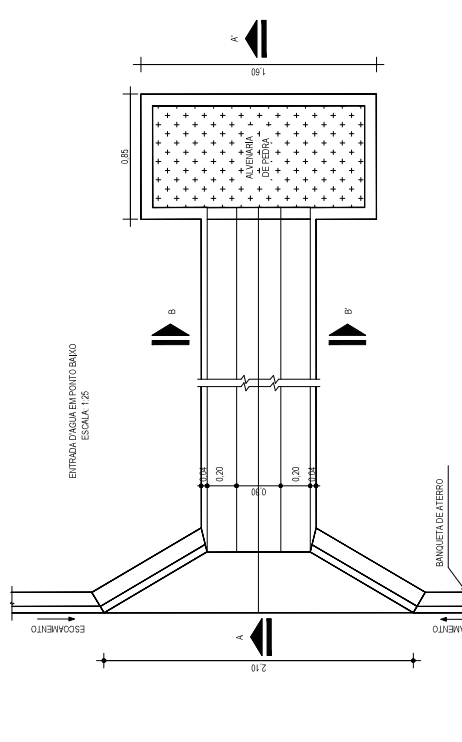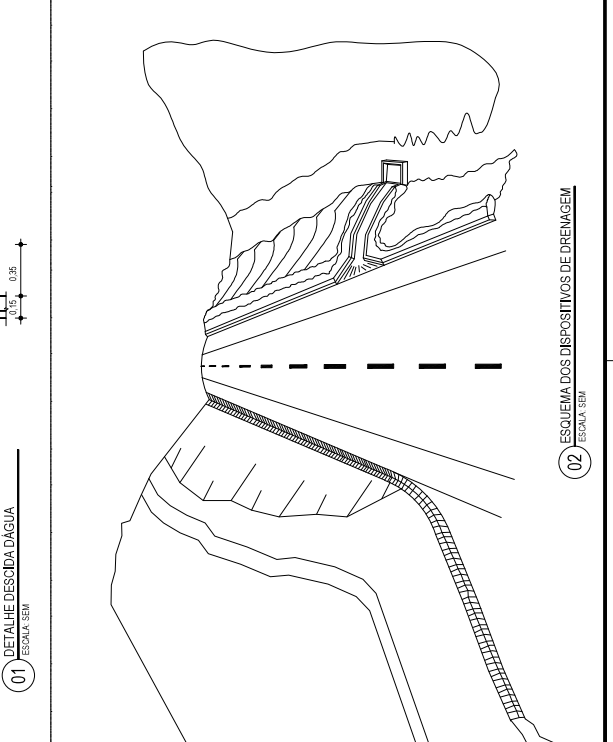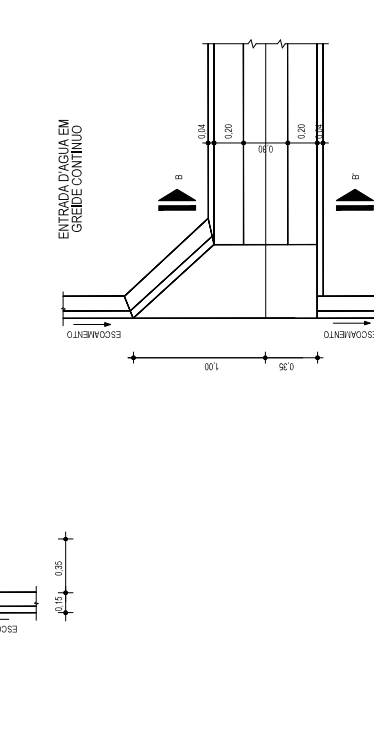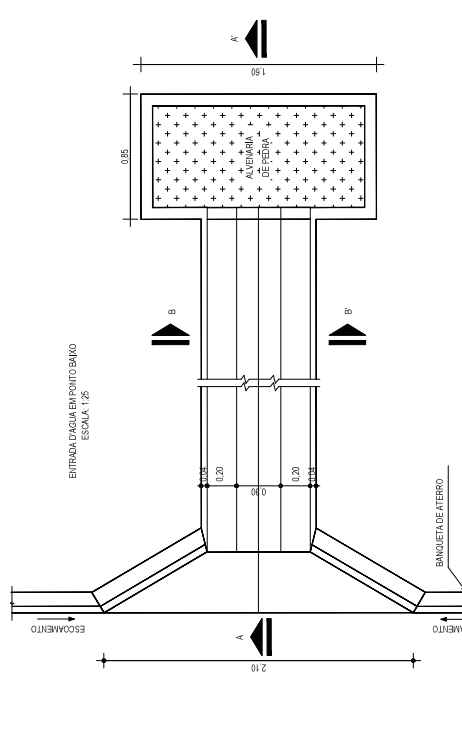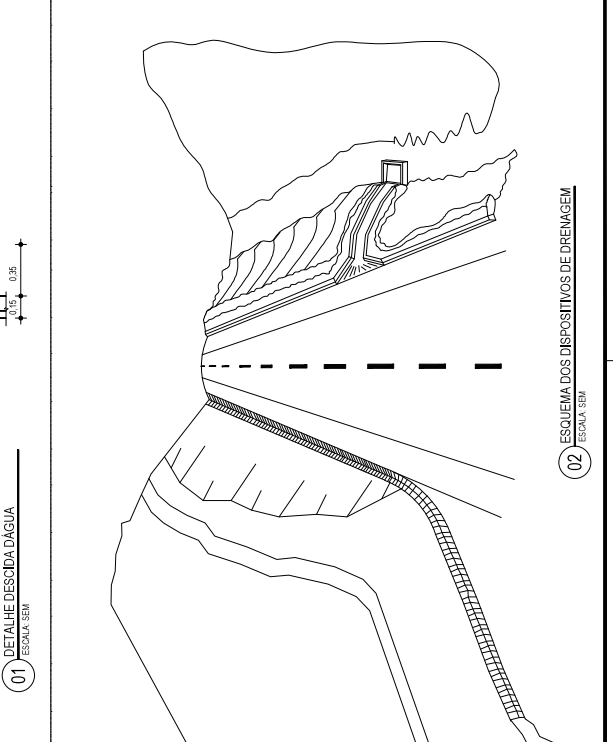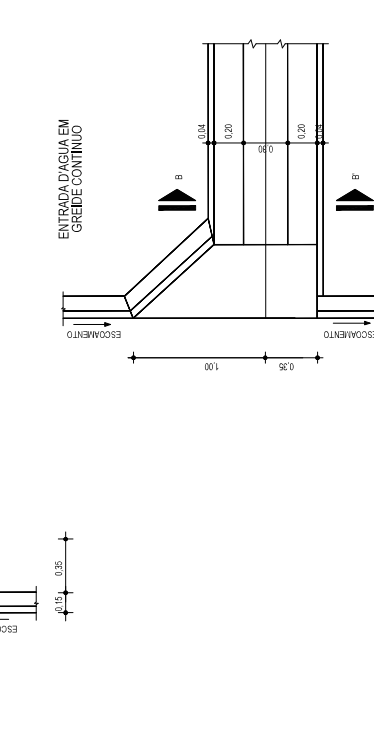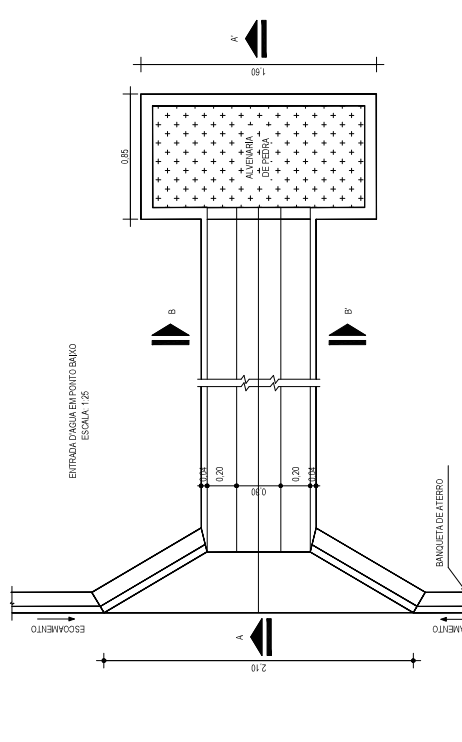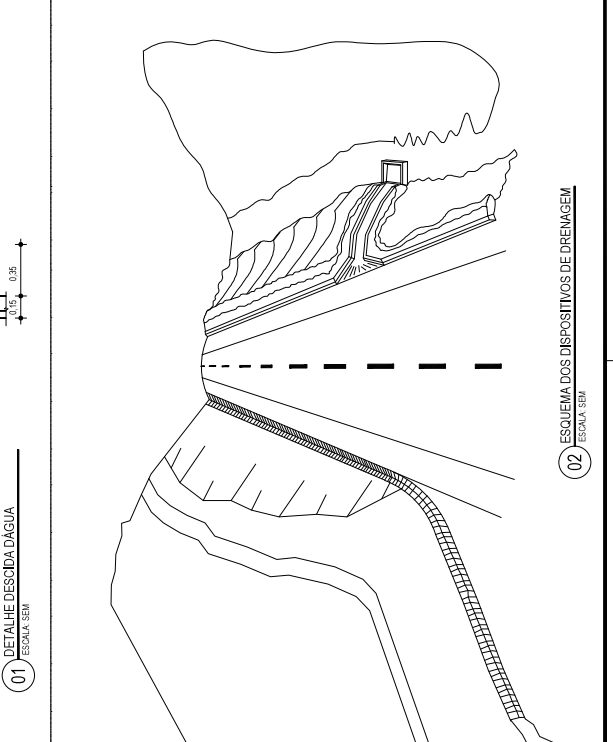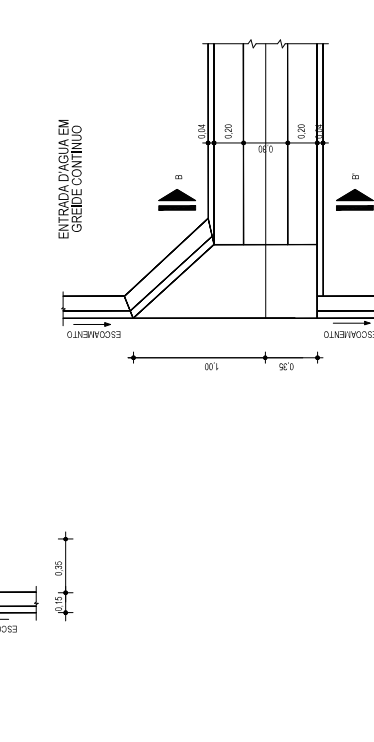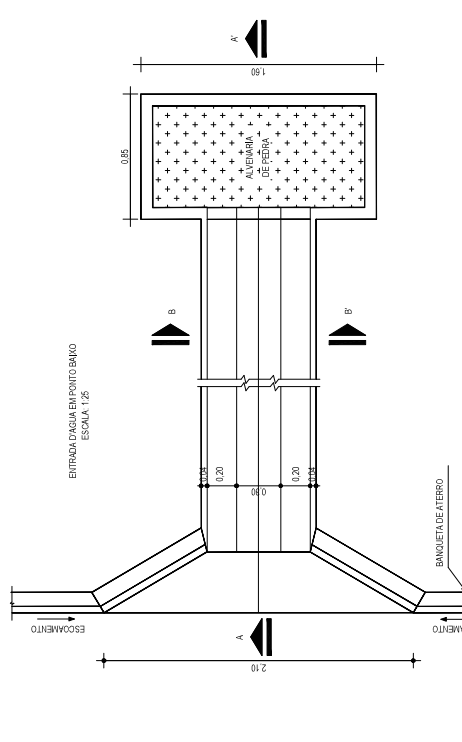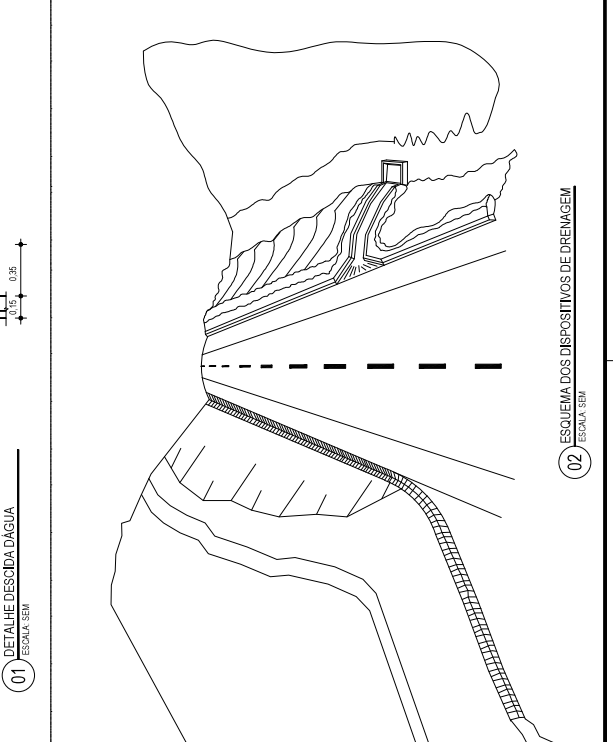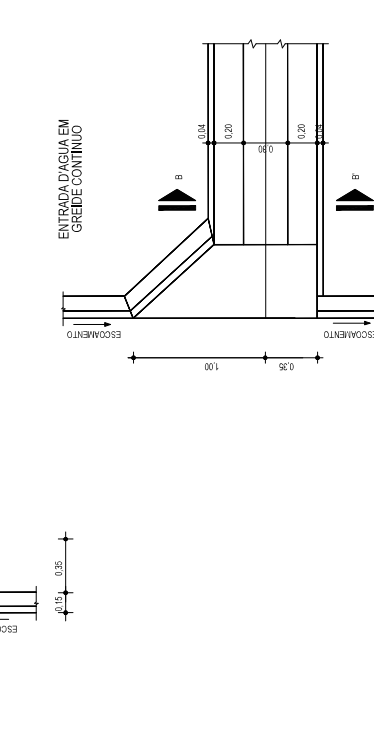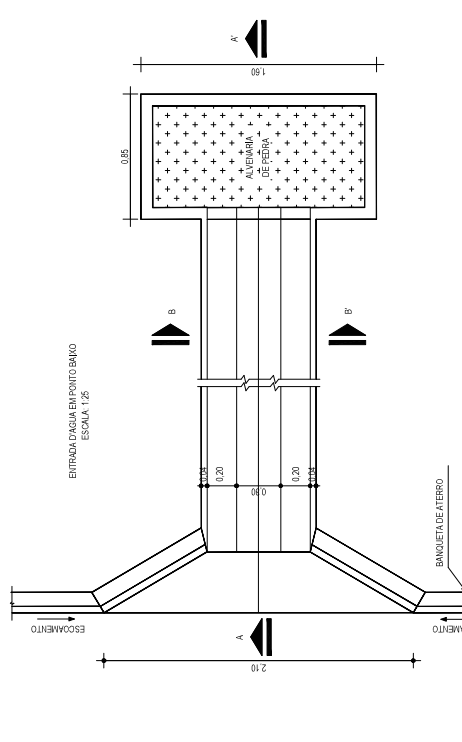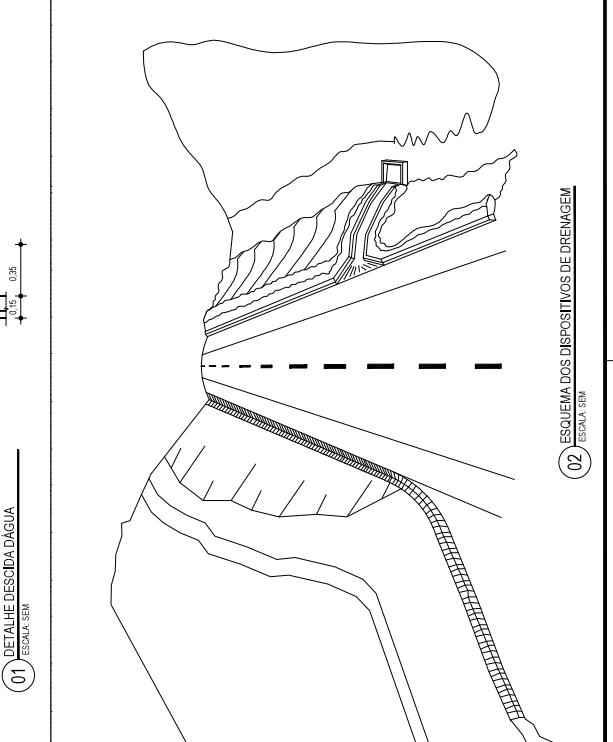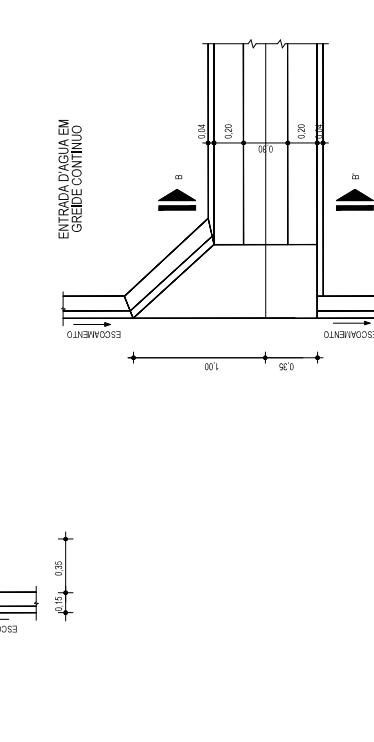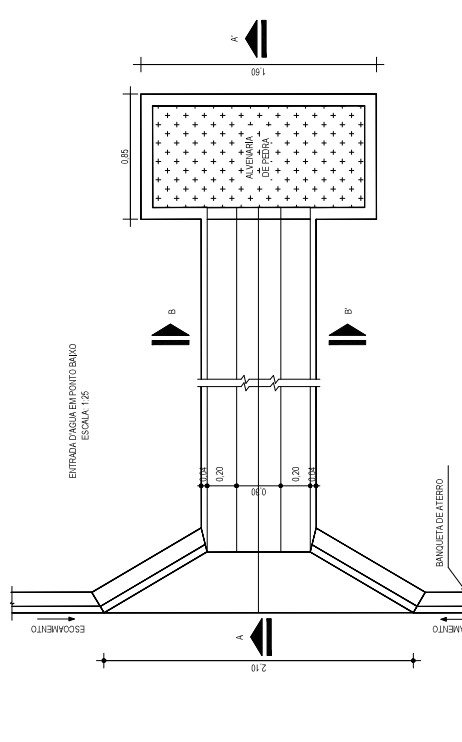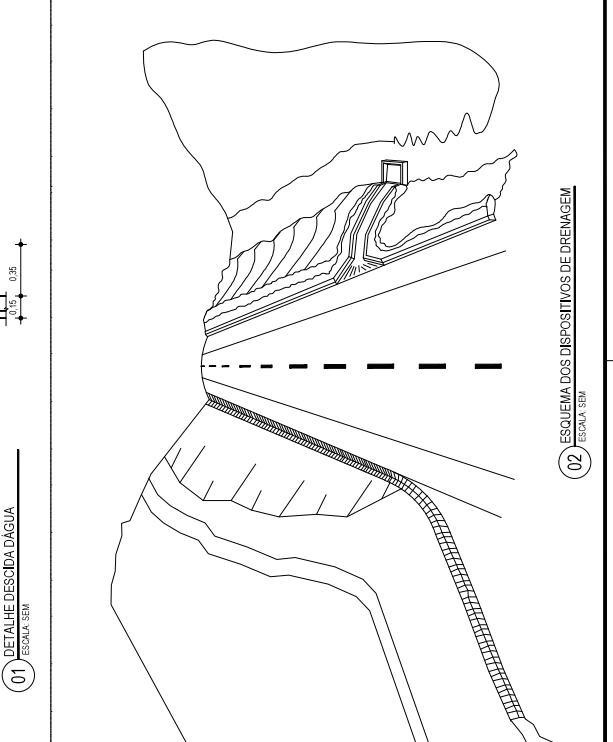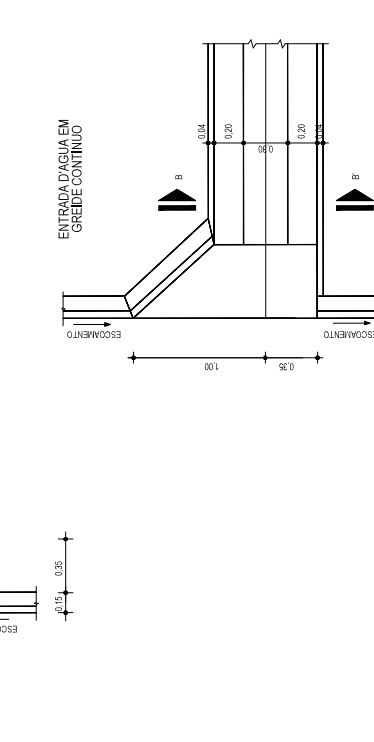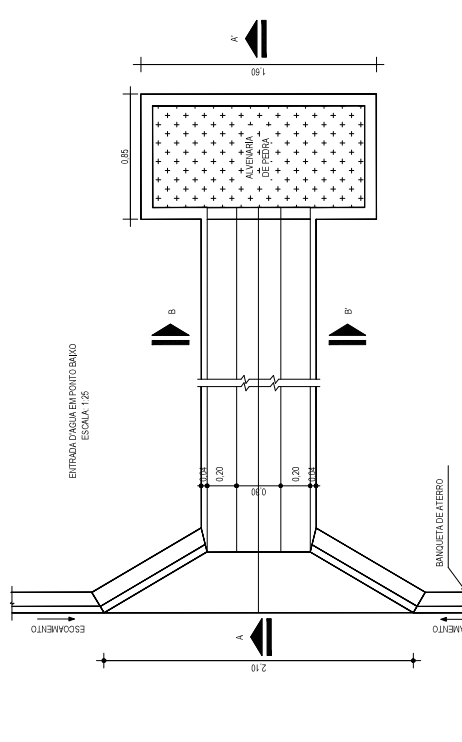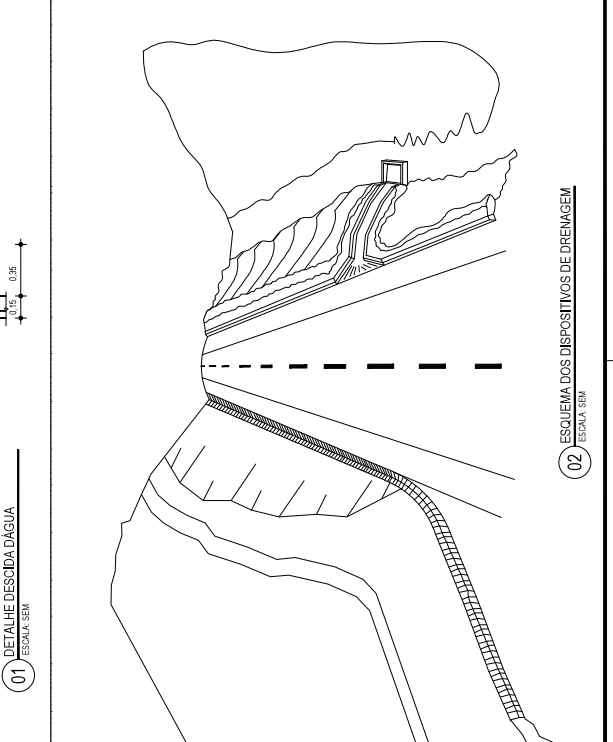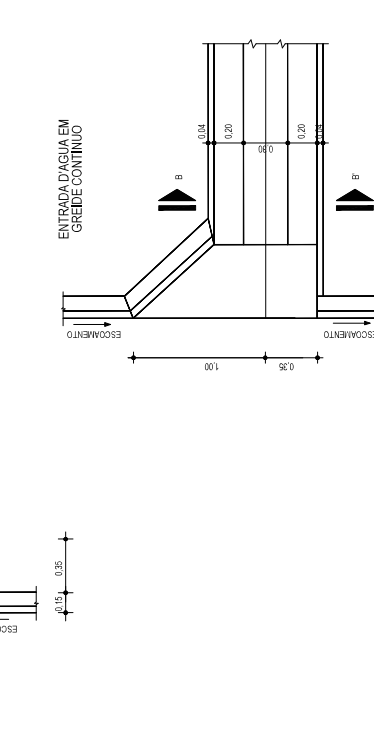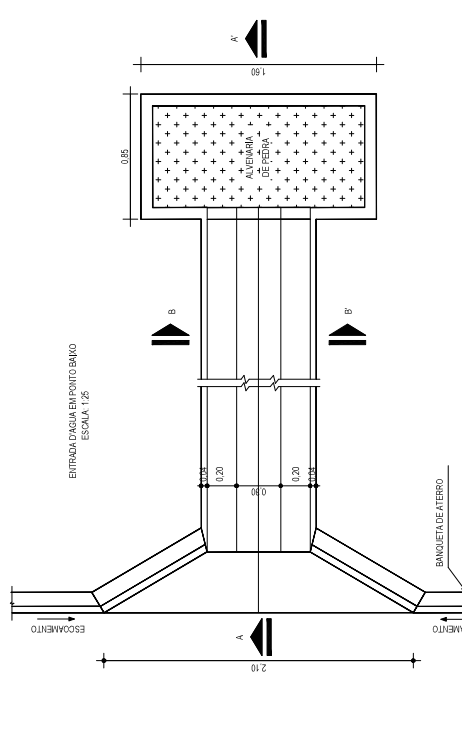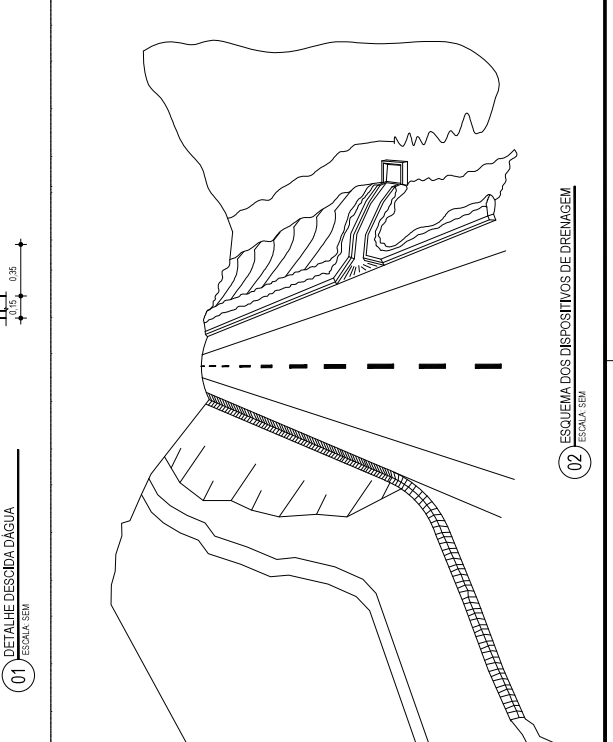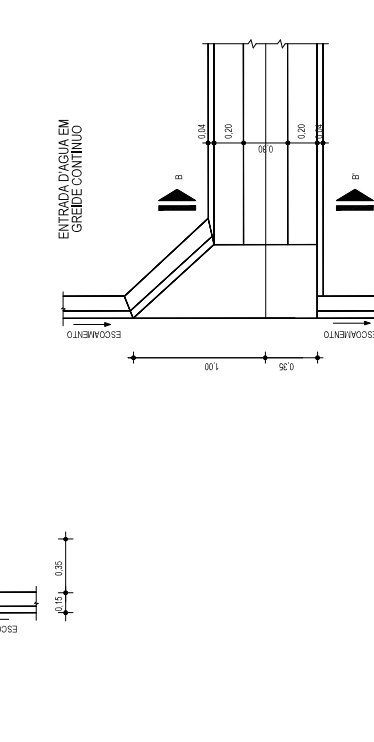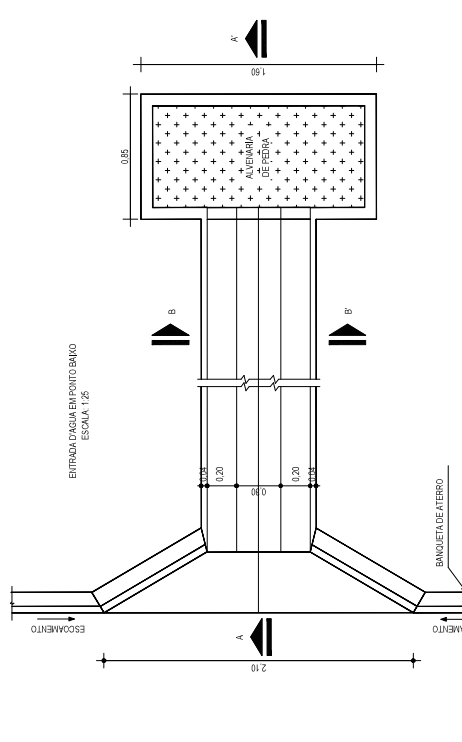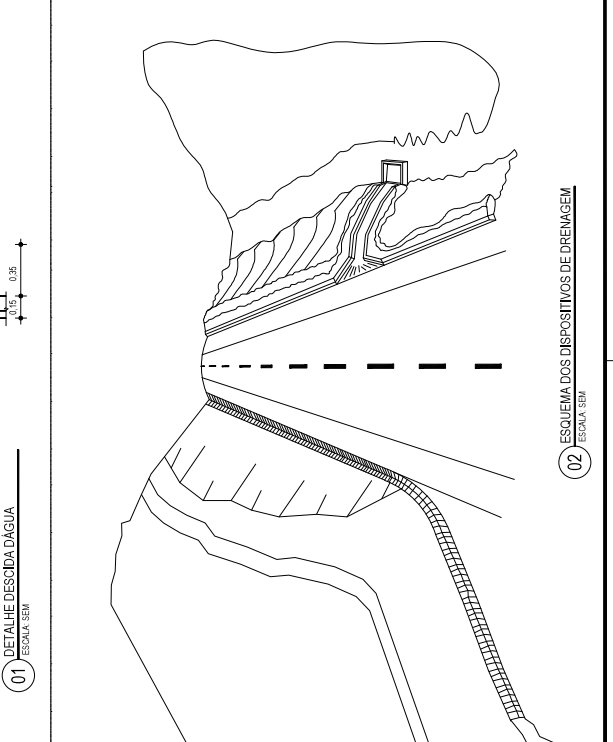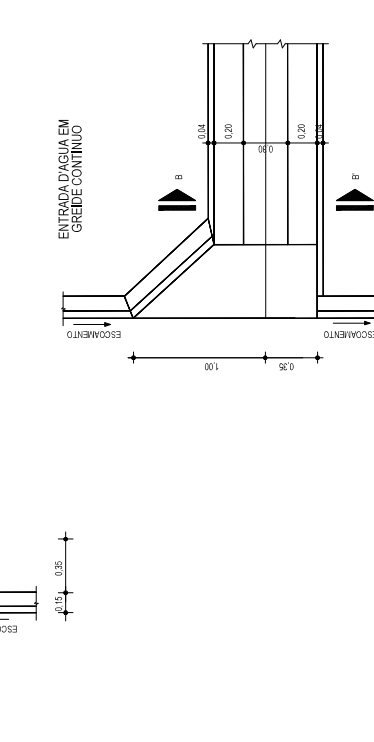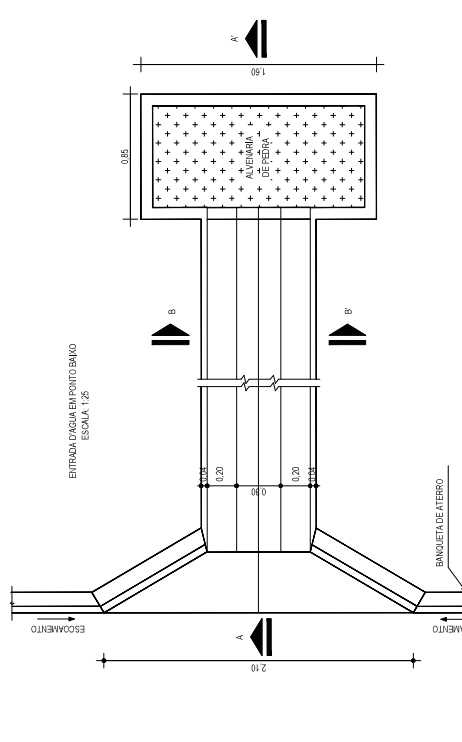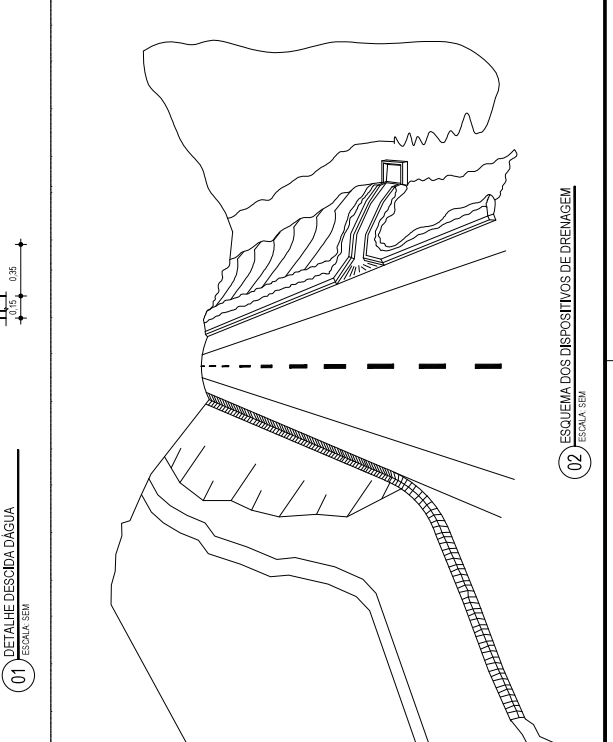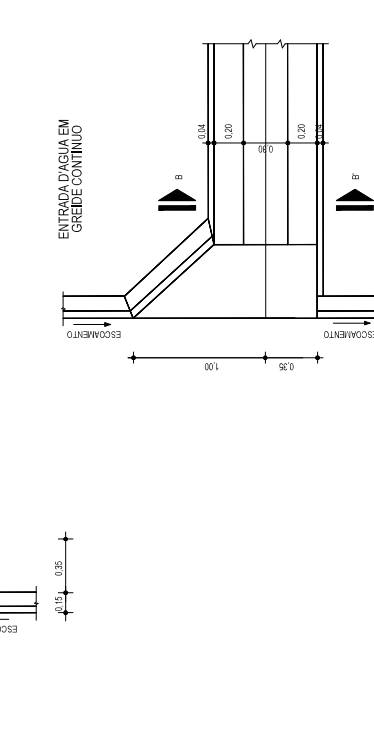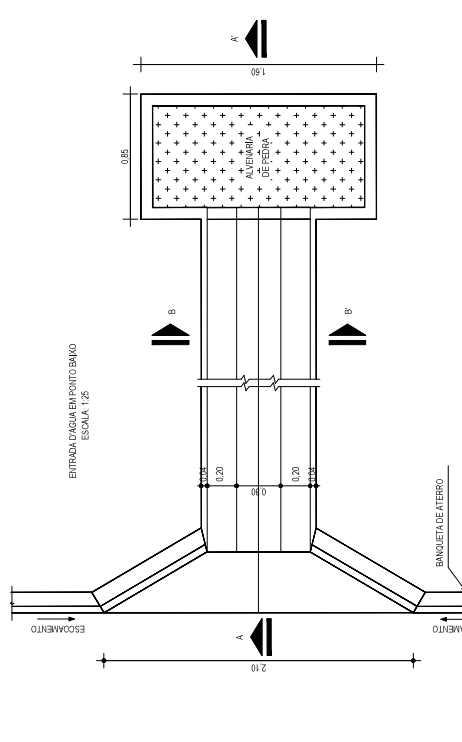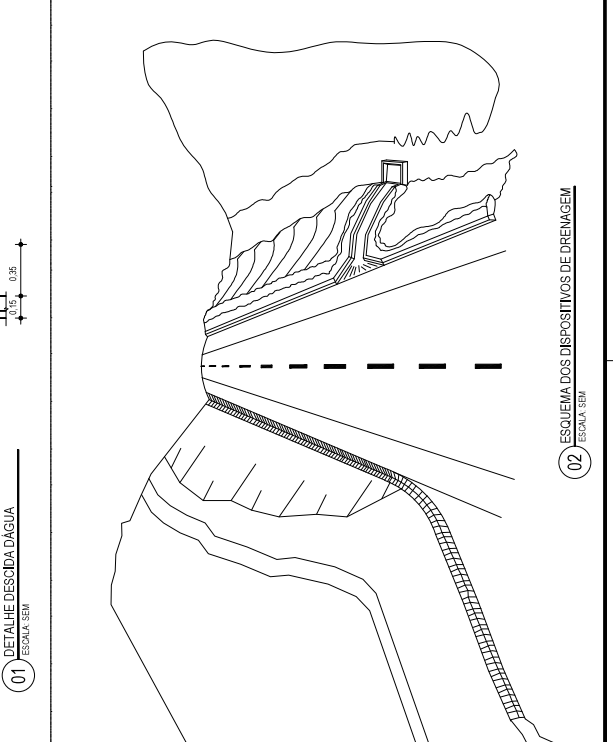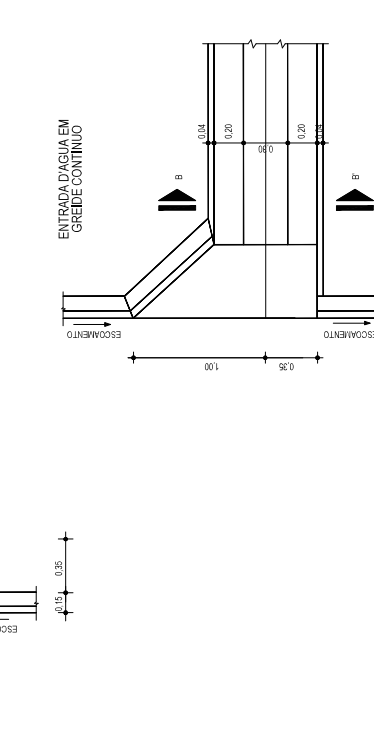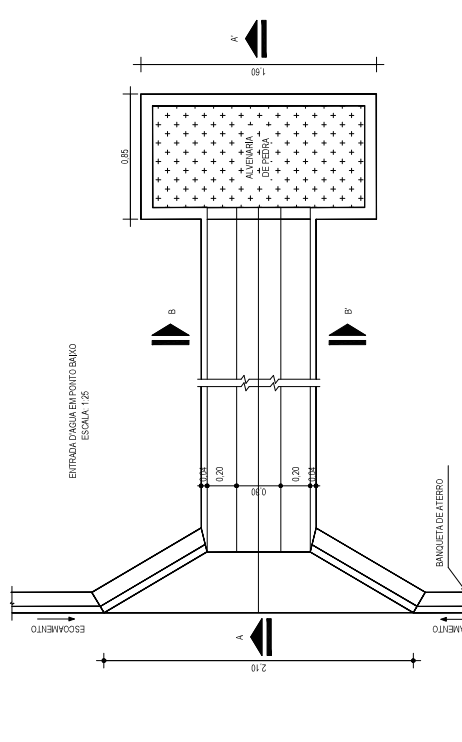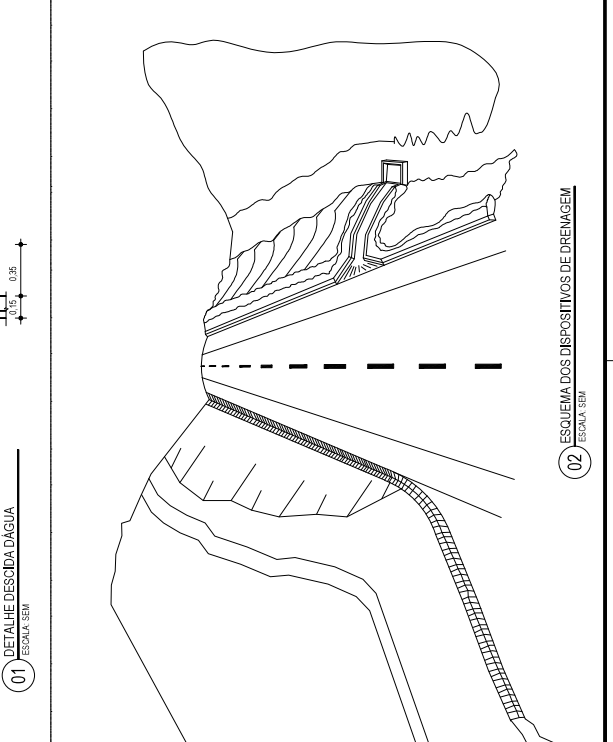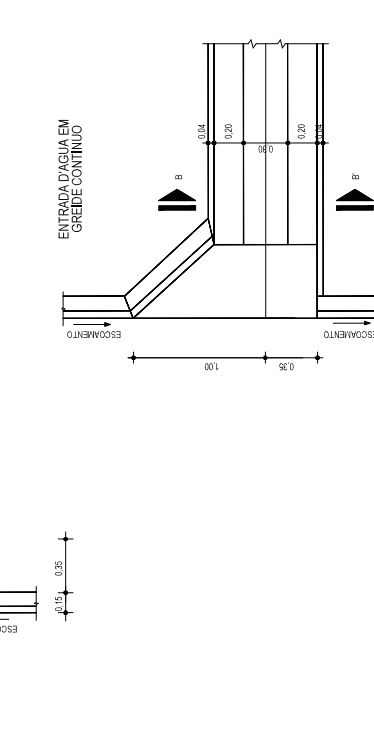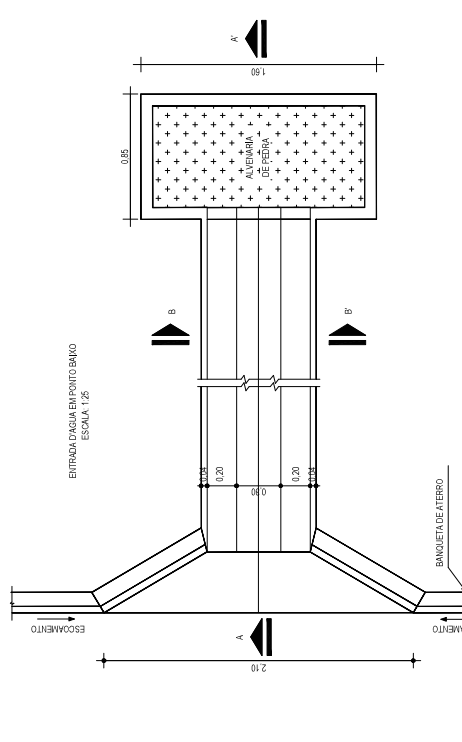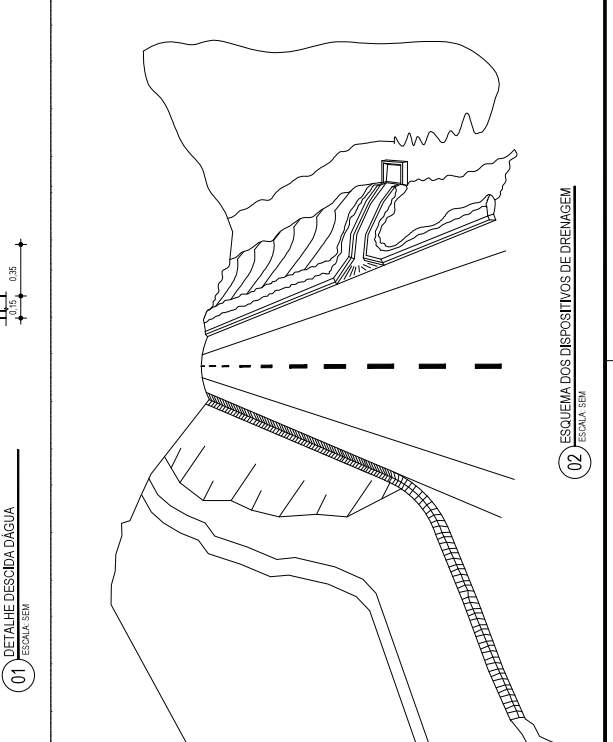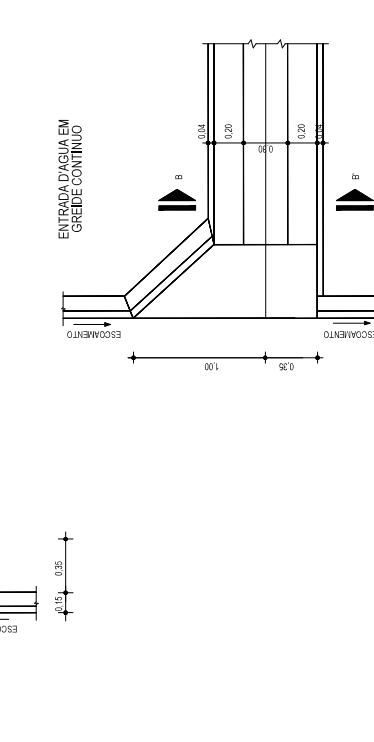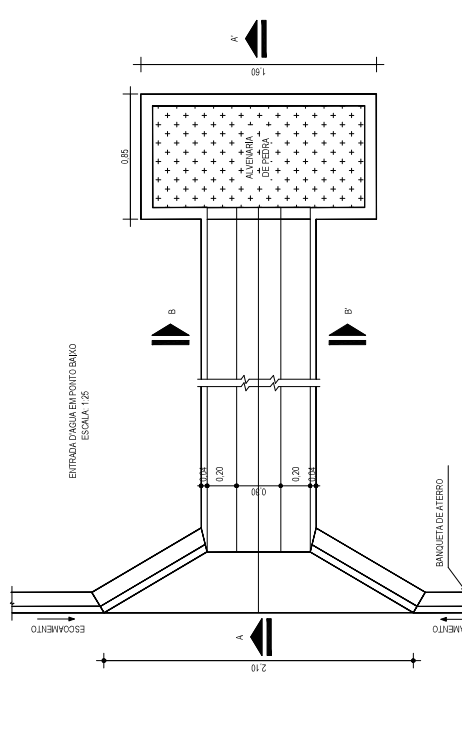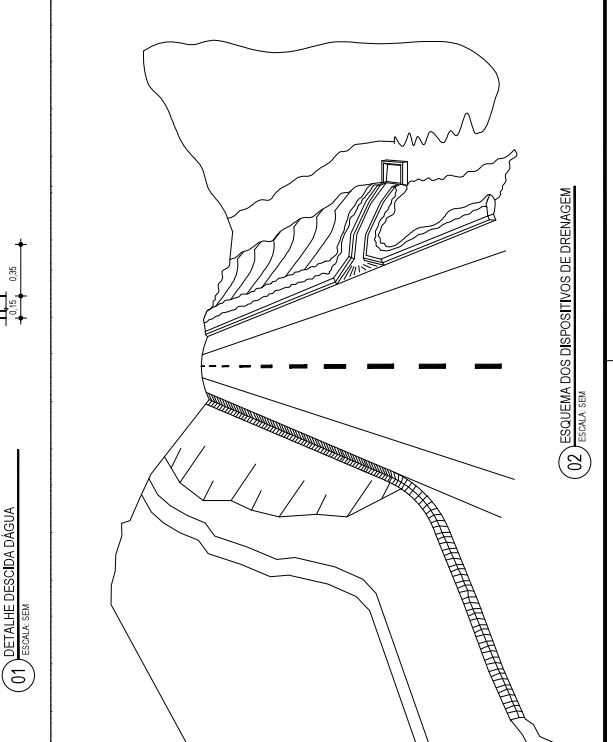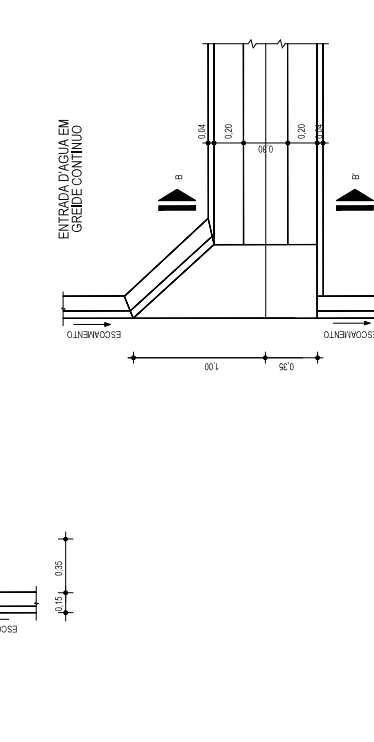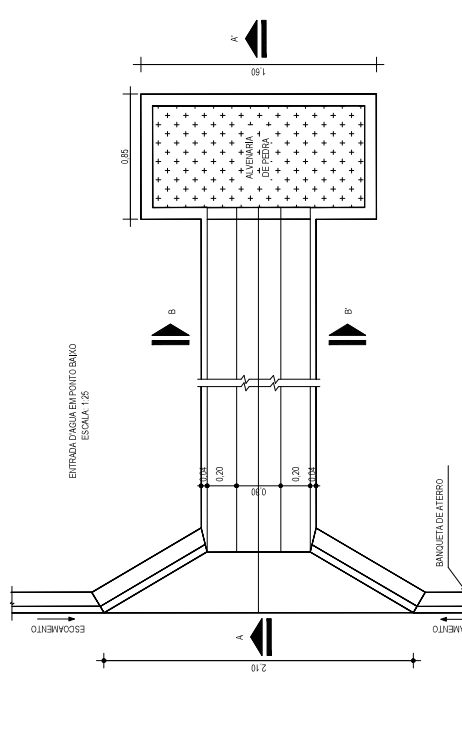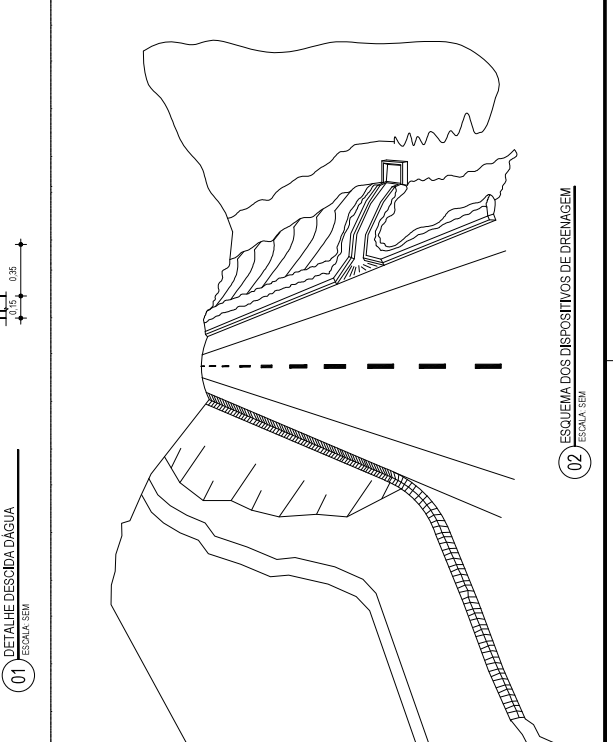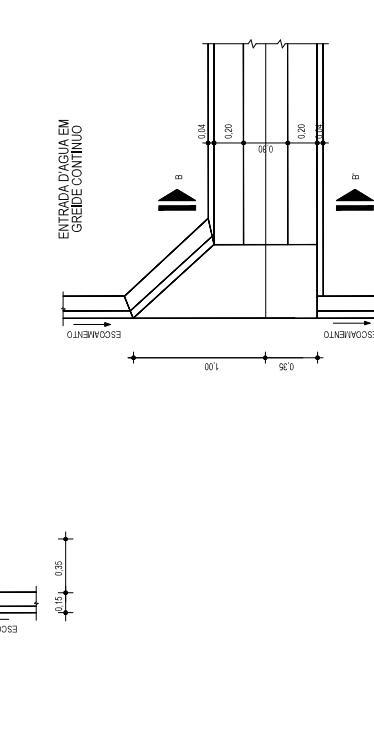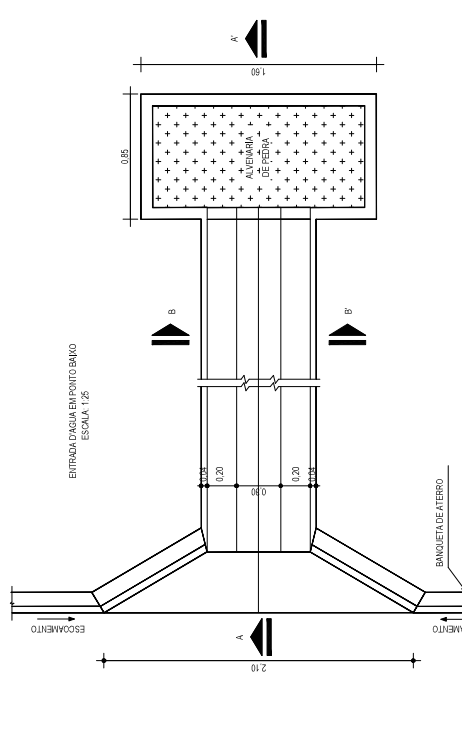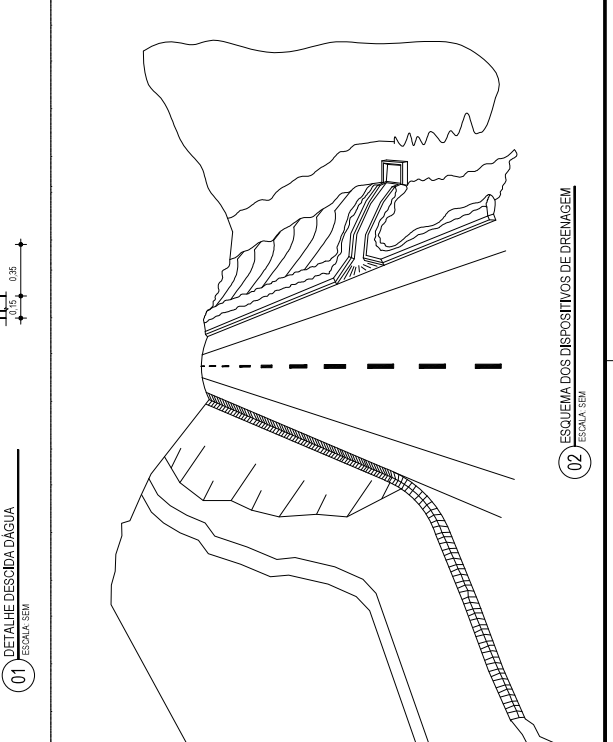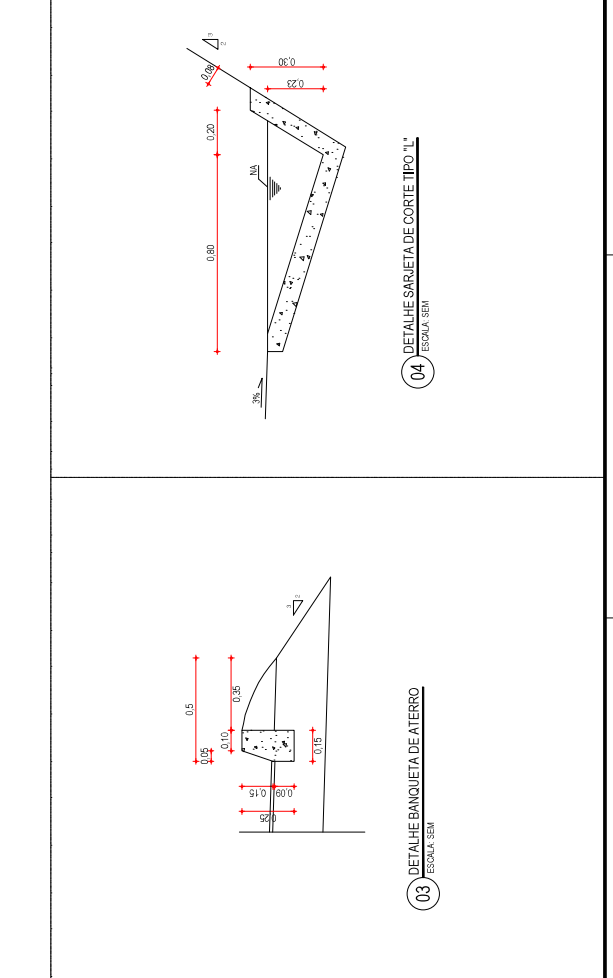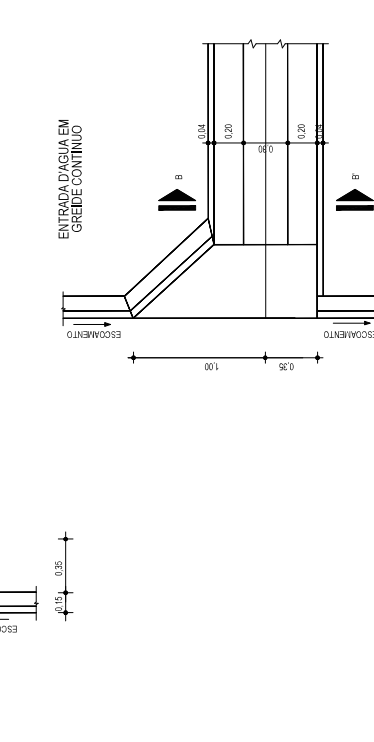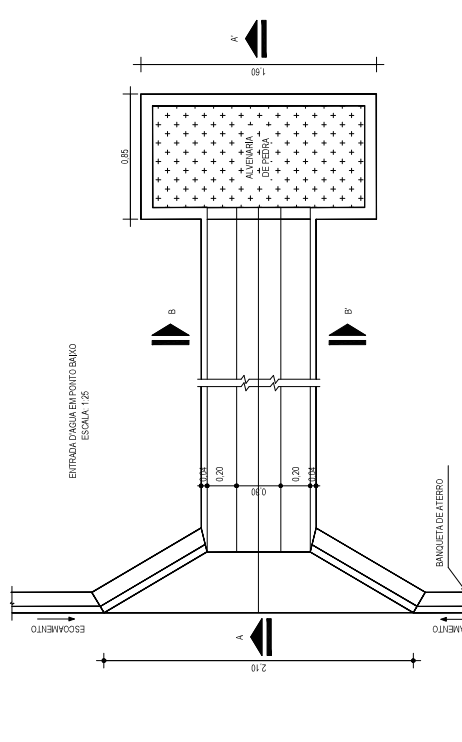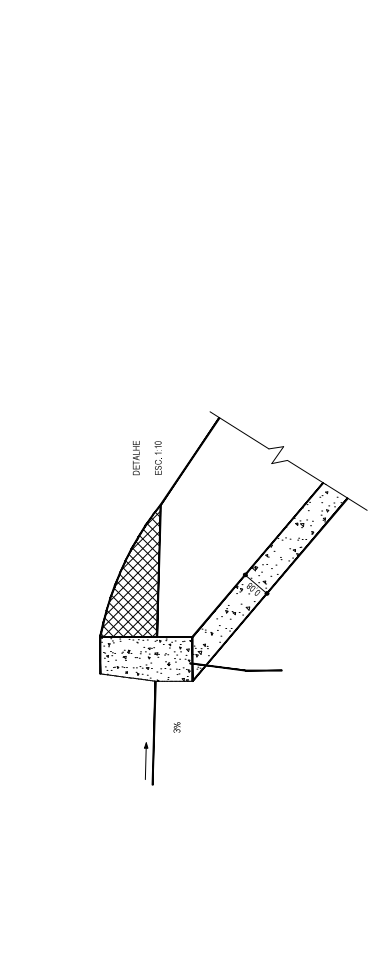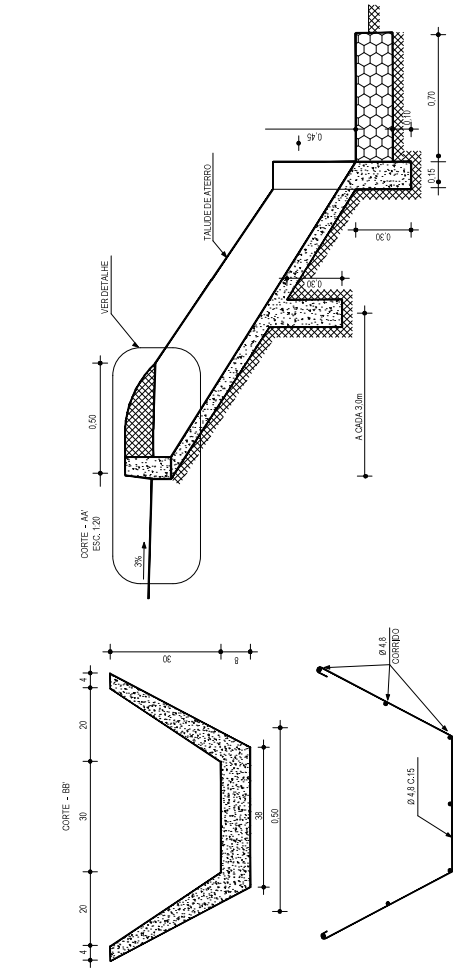


NOTAS

AS ETAPAS EXECUTIVAS A SEREM ATENDIDAS NA CONSTRUÇÃO DOS BUEIROS TUBULARES DE CONCRETO SÃO AS SEGUINTE:


- A LOCAÇÃO SERÁ EFETUADA COM PIQUETES ESPAÇADOS DE 5M., A DECLINAÇÃO LONGITUDINAL DA OBRA DEVERÁ SER CONTÍNUA,
- ESCAVACÃO DAS TRINCHERAS NECESSÁRIAS A MOLDAGEM DOS BERÇOS, A QUAL PODERÁ SER EXECUTADA MANUAL OU MECANICAMENTE, DEVENDO SER PREVISTA UMA LARGURA SUPERIOR EM 30CM À DO BERÇO, PARA CADA LADO,
- INSTALAÇÃO DAS FORMAS, LATERAIS AOS BERÇOS;
- EXECUÇÃO DA PORÇÃO INFERIOR DO BERÇO EM ALVENARIA DE PEDRA ARGAMASSADA, ATÉ SE ATINGIR A LINHA CORRESPONDENTE A GERATRIZ INFERIOR DOS TUBOS;
- INSTALAÇÃO DOS TUBOS SOBRE A PORÇÃO INFERIOR DO BERÇO, TÃO LOGO A ALVENARIA DE PEDRA ARGAMASSADA APRESENTE RESISTÊNCIA PARA ISTO, SE NECESSÁRIO, UTILIZAR GUIAS OU CALÇOS DE MADEIRA OU DE CONCRETO;
- PRÉ-MOLDADO PARA FIXAR OS TUBOS NA POSIÇÃO CORRETA;
- COMPLETAMENTO DO BERÇO, IMEDIATAMENTE APÓS A INSTALAÇÃO DOS TUBOS, RETIRADA DAS FORMAS;
- REJUNTAMENTO DOS TUBOS COM ARGAMASSA DE CIMENTO-AREIA, TRAÇÃO 1:4;
- EXECUÇÃO DO REATERRO, PREFERENCIALMENTE COM O PRÓPRIO MATERIAL ESCAVADO, DESDE QUE SEJA DE BOA QUALIDADE, CASO NÃO SEJA, IMPORTAR MATERIAL SELECIONADO, A COMPACTAÇÃO DO MATERIAL DE REATERRO DEVERÁ SER EXECUTADA EM CAMADAS INDIVIDUAIS DE NO MÁXIMO 15CM DE ESPESURA, POR MEIO DE COMPACTADORES MANUAIS, TIPOS PLACAS, VIBRATORIAS OU SOQUETES MECÂNICOS, O EQUIPAMENTO UTILIZADO DEVERÁ SER COMPARTEVEL COM O ESPAÇO PREVISTO NO PROJETO; TIPO ENTRE LINHAS DE TUBOS DE BUEIROS DUPLS OU TRIPLOS; ESPECIAL ATENÇÃO DEVERÁ SER DADA NA COMPACTAÇÃO JUNTO AS PAREDES DOS TUBOS, O REATERRO DEVERÁ PROSSIGUIR ATÉ SE ATINGIR UMA ESPESURA DE 90CM ACIMA DA GERATRIZ SUPERIOR EXTERNA DO CORPO DO BUEIRO.
- EXECUÇÃO DAS BOCAS DE MONTANTE E JUSANTE, CASO AS BOCAS DE MONTANTE SEJAM DO TIPO CAIXA COLETOIRA DE SARJETAS (BUEIROS DE GREIDE) OU DE TALVEGUE (BUEIRO DE GROTA), DEVERÃO SER ATENDIDOS PROCEDIMENTOS EXECUTIVOS PREVISTOS NA ESPECIFICAÇÃO CORRESPONDENTE A ESTES DISPOSITIVOS;
- CONCLUÍDAS AS BOCAS, DEVERÃO SER VERIFICADAS AS CONDIÇÕES DE CANALIZAÇÃO A MONTANTE E JUSANTE DA OBRA, TODAS AS EROSOES ENCONTRADAS E QUE POSSAM VIR A COMPROMETER O FUNCIONAMENTO DA OBRA DEVERÃO SER TRATADAS COM ENROCAMENTO DE PEDRA ARMADA OU POR SOLUÇÕES ESPECÍFICAS DO PROJETO, DEVERÃO SER EXECUTADAS AS NECESSÁRIAS VALAS DE DERRAMAÇÃO, A JUSANTE, E BACIAS DE CAPTAÇÃO, A MONTANTE, DE FORMA A DISCIPLINAR A ENTRADA E SAÍDA DO FLUXO D'ÁGUA NO BUEIRO.

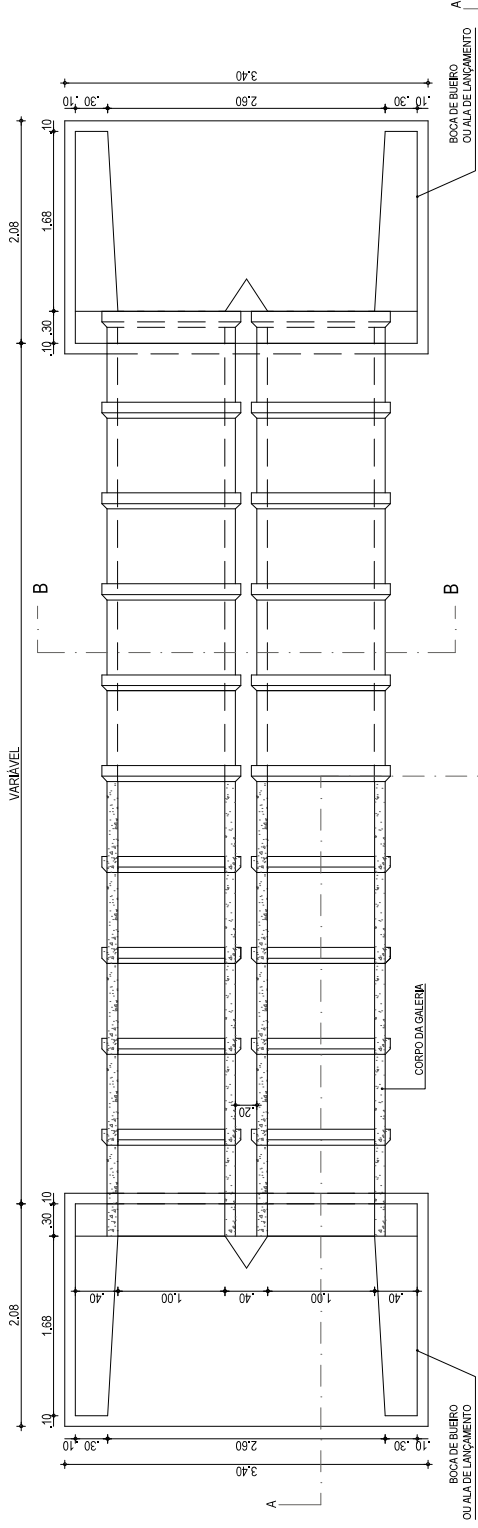


01 PLANTA BAIXA
ESCALA: 1/50

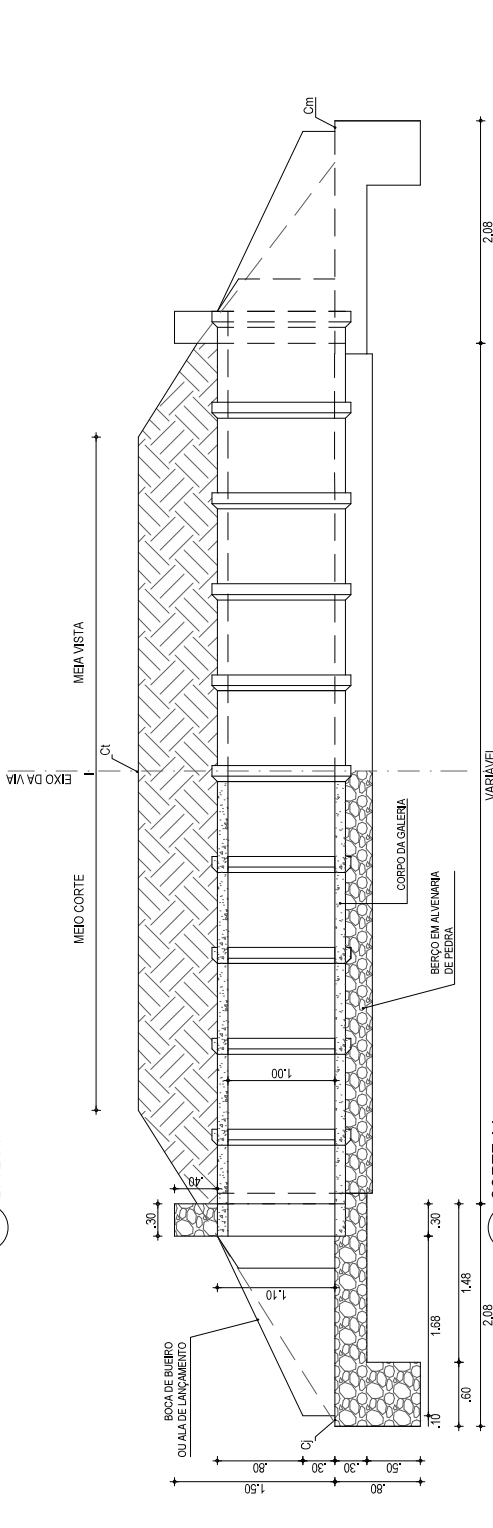

02 CORTE AA
ESCALA: 1/50

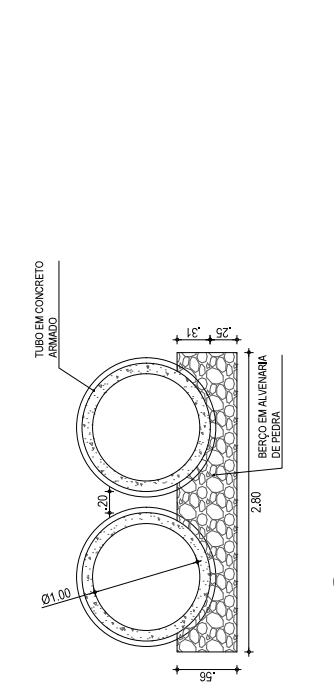

03 VISTA FRONTAL
ESCALA: 1/50

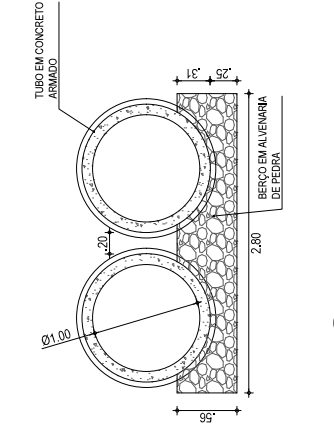

04 CORTE BB
ESCALA: 1/50

ASSINATURAS E APROVAÇÃO

PROJETISTA

PROPRIETÁRIO

LEONARDO SILVEIRA LIMA
ENGENHEIRO CIVIL - RNP: 9901581097

APROVAÇÃO



PROPRIETÁRIO
PREFEITURA MUNICIPAL DE ARACATI

OBRA: **PAVIMENTAÇÃO NA LOCALIDADE DE JIRAU À PEIXOTO EM ARACATICE**

CONTEÚDO: **PAVIMENTAÇÃO NA LOCALIDADE DE JIRAU À LOCALIDADE DE PEIXOTO**


PROJETO DE DRENAGEM

IDENTIFICAÇÃO DOS DESENHOS:


- 01. PLANTA BAIXA
- 02. CORTE AA
- 03. VISTA FRONTAL
- 04. CORTE BB

LOCAL: JIRAU - ARACATICE	DATA: JULHO 2018	PRARQUIA: 39-b/48
DESENHO:	ESCALA: INDICADA	CONTROLADO: ARCT 2018-41


NOTAS

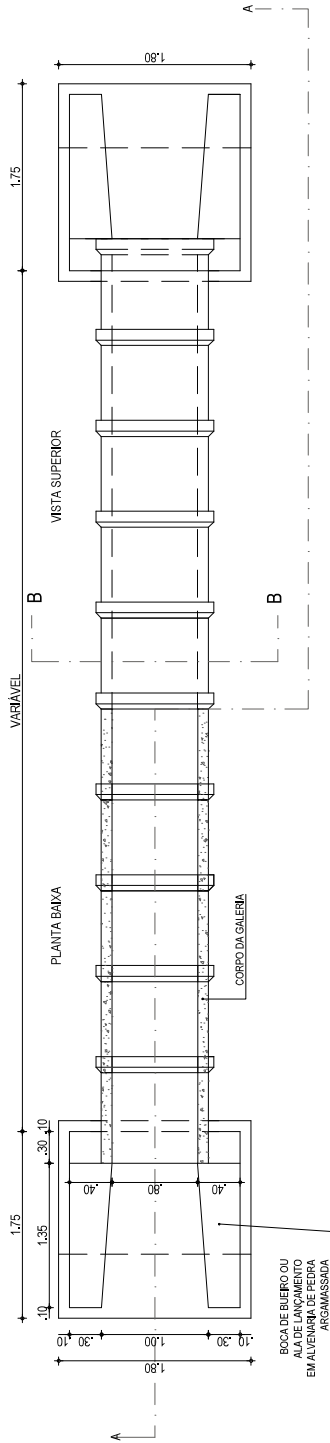


01 PLANTA BAIXA
ESCALA: 1:50

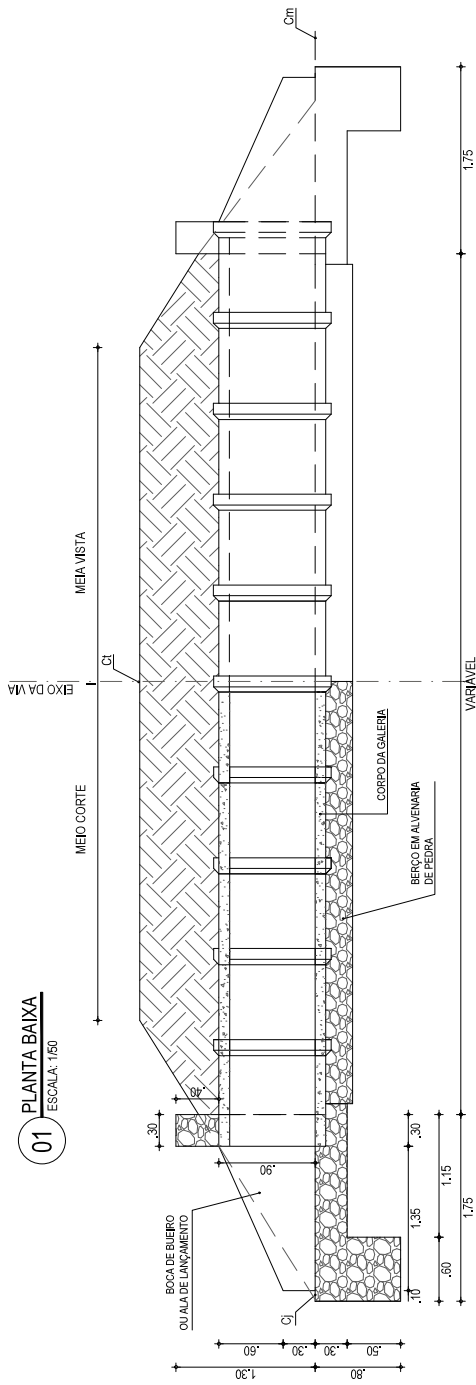

02 CORTE AA
ESCALA: 1:50

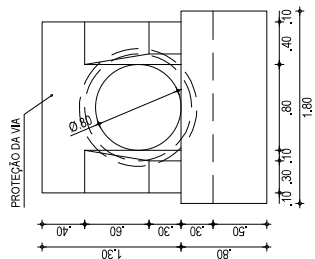

03 VISTA FRONTAL
ESCALA: 1:50

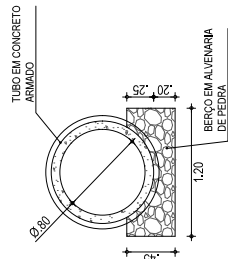

04 CORTE BB
ESCALA: 1:50

ASSINATURAS E APROVAÇÃO

PROJETISTA

PROPRIETÁRIO

LEONARDO SILVEIRA LIMA
ENGENHEIRO CIVIL - RNP: 060158/087

APROVAÇÃO

GEPAC
AV. PADRE ANTONIO TOMAS, N.º 200, SALA 501
BARRIO ALDEGIA FORTALEZA
FONE: 85.3241.3147 | EMAIL: GEPAC@GEPAC.COM.BR

PREFEITURA MUNICIPAL DE ARACATI

PROJETO: PAVIMENTAÇÃO NA LOCALIDADE DE JIRAU À PEIXOTO EM ARACATICE

OBRA: PAVIMENTAÇÃO NA LOCALIDADE DE JIRAU À LOCALIDADE DE PEIXOTO

CONTEUDO: PROJETO DE DRENAGEM

IDENTIFICAÇÃO DOS DESENHOS:

01. PLANTA BAIXA

02. CORTE AA




03. VISTA

04. CORTE BB

LOCAL: JIRAU - ARACATICE
PRARCHA: 39-C/48
DATA: JULHO 2018
ESCALA: INDICADA
CONTROLE: ARCT 2018-41
DESENHO: INDICADA

LEGENDA	
	MEIO AMBIENTE
	MEIO PROJETADO
	CORTA
	MARGEM
	ALINHAMENTO ESTACÃO
	PAVIMENTO
	VEGETAÇÃO
	A-18
	A-19
	A-20
	A-100

NOTA:
 1. O PROJETO DEVE SER EXECUTADO DE ACORDO COM O PROJETO DE ALINHAMENTO E PAVIMENTO.
 2. O PROJETO DEVE SER EXECUTADO DE ACORDO COM O PROJETO DE DRENAGEM E SINALIZAÇÃO.

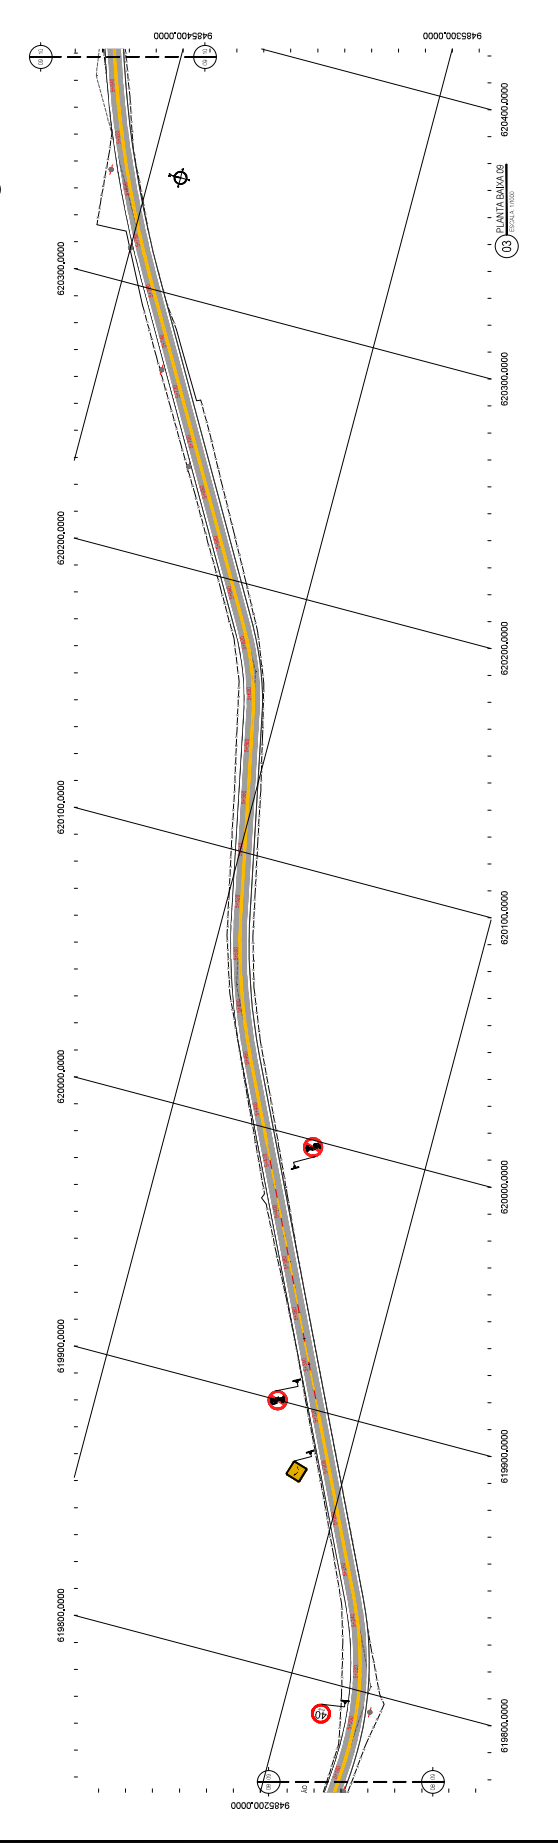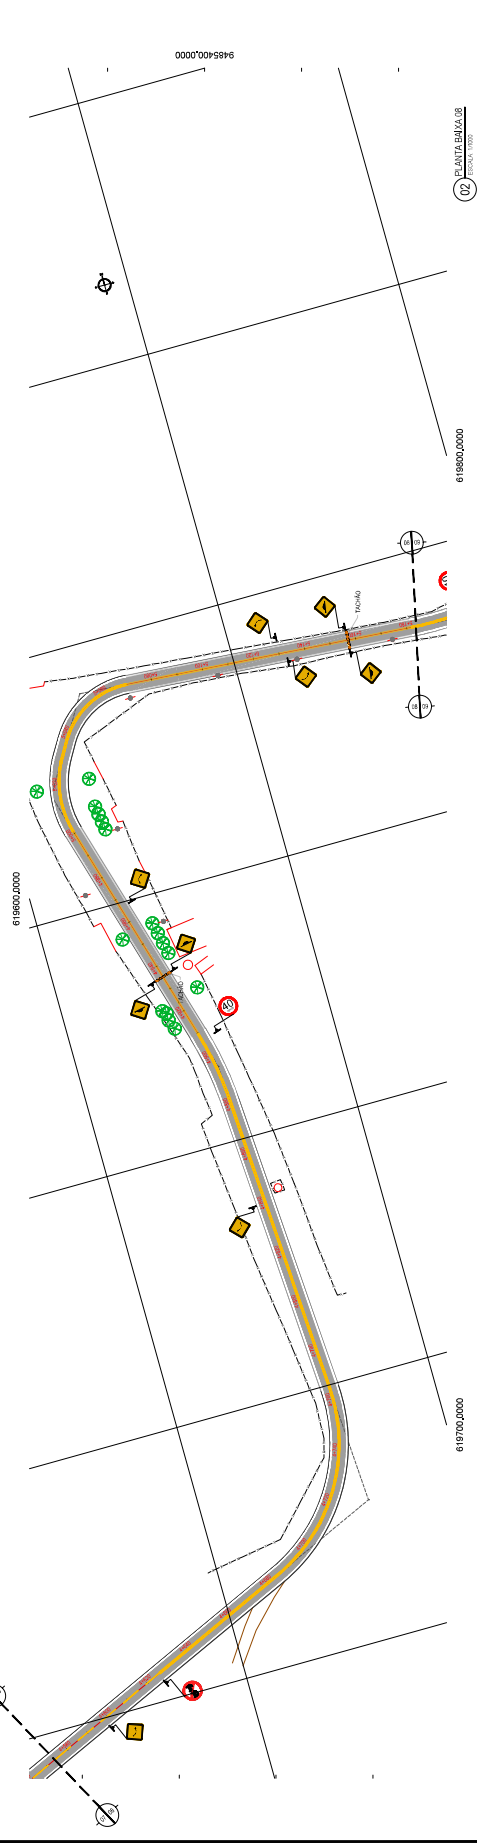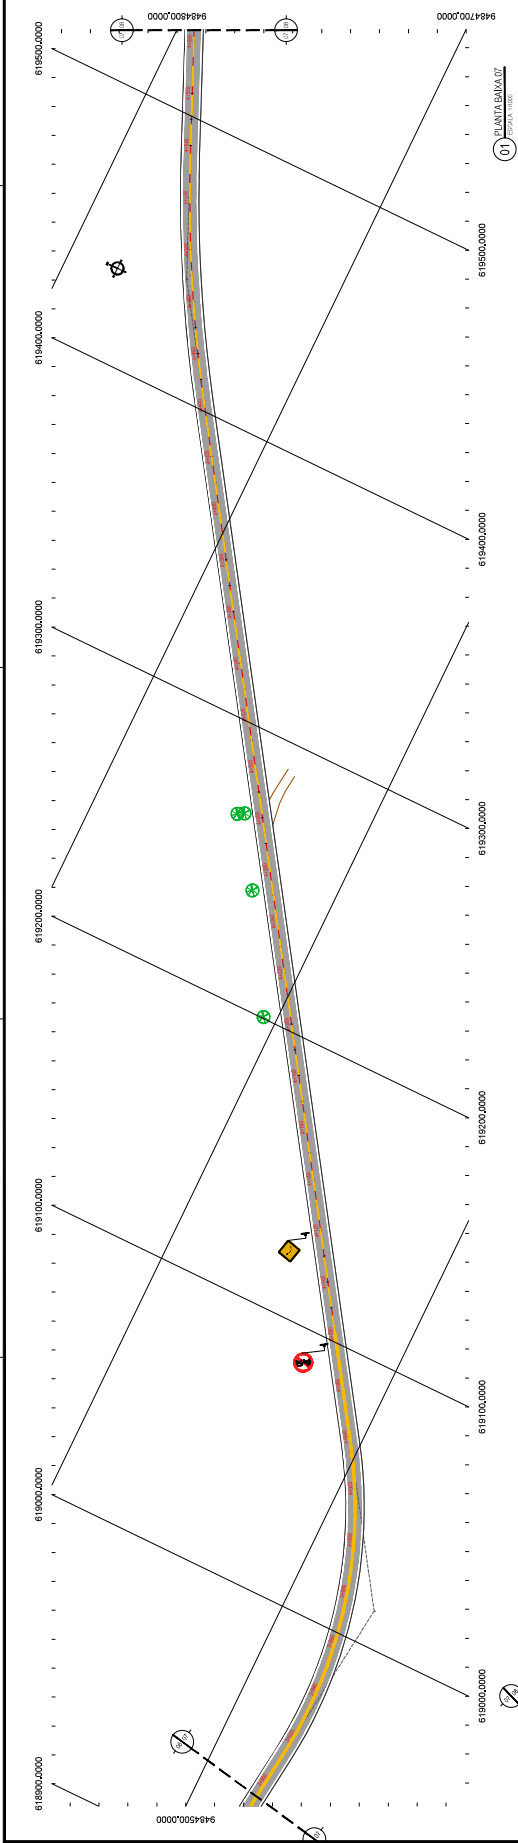

RESUMO DE APROVAÇÃO

PROJETO Nº: 01/2023

LEONARDO DA SILVA LIMA
 LICENCIADO EM ENGENHARIA DE TRANSPORTES
 Nº de Registro Profissional: 123456789

PREFETURA MUNICIPAL DE ARAÇATI

PAVIMENTAÇÃO NA LOCALIDADE DE BARRA LOCALIDADE DE BARRA

BRASILEIRO DE ENGENHARIA

4218

GEO PAC

PROJETO Nº: 01/2023

LEONARDO DA SILVA LIMA
 LICENCIADO EM ENGENHARIA DE TRANSPORTES
 Nº de Registro Profissional: 123456789

PREFETURA MUNICIPAL DE ARAÇATI

PAVIMENTAÇÃO NA LOCALIDADE DE BARRA LOCALIDADE DE BARRA

BRASILEIRO DE ENGENHARIA

4218

PLACAS DO TRECHO

PLACAS	CODIGO	DIMENSÕES (mm)
	R-7	Ø=1.00
	R-19.4	Ø=1.00
	R-1	Ø=1.00

PLACAS DE ADVERTÊNCIA

PLACAS	CODIGO	DIMENSÕES (mm)
	A-2a	1.00x1.00
	A-2b	1.00x1.00
	A-18	1.00x1.00
	A-3a	1.00x1.00
	A-3b	1.00x1.00

NOTAS

1. CARACTERÍSTICAS DAS PLACAS REGULAMENTARES
2. CARACTERÍSTICAS DAS PLACAS DE ADVERTÊNCIA

DIMENSÕES		MEDIDAS	
Função	Travessia	Função	Travessia
Forma	Quadrada	Forma	Quadrada
Material	Alumínio	Material	Alumínio
Cor	Amarelo	Cor	Amarelo
Reflexividade	Alta	Reflexividade	Alta
Fixação	Parafusos	Fixação	Parafusos


ASSINATURAS E APROVAÇÃO

PROJETISTA:
LEONARDO SILVEIRA LIMA
ENGENHEIRO CÍVIL - RFB 08189/07




PREFEITURA MUNICIPAL DE ARACATI
PÁVIMENTO NA LOCALIDADE DE JIRAU À REVOZADO EM ARACATI
PROJETO DE: PAVIMENTAÇÃO NA LOCALIDADE DE JIRAU À LOCALIDADE DE PEIXOTO
CONTENIDO: PROJETO DE SINALIZAÇÃO - DETALHE DE SINALIZAÇÃO VERTICAL



PROJETO	47/18
DATA	JULHO/2018
LOCAL	ARACATI
PROJETA	ARACATI

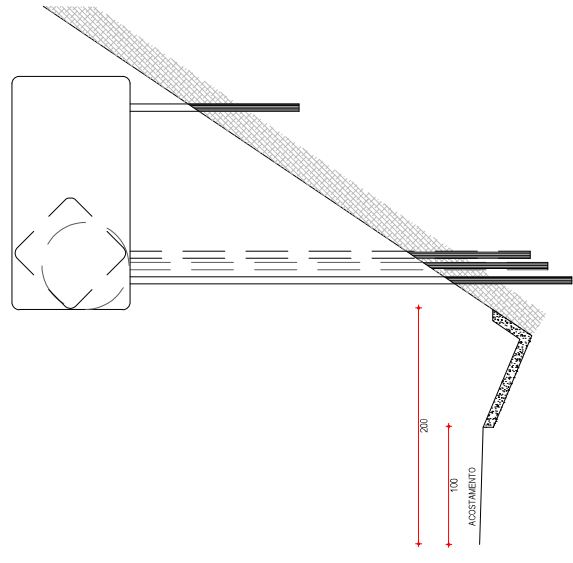

02 DETALHE PLACAS INDICATIVAS EM CORTE
ESCALA: SEM

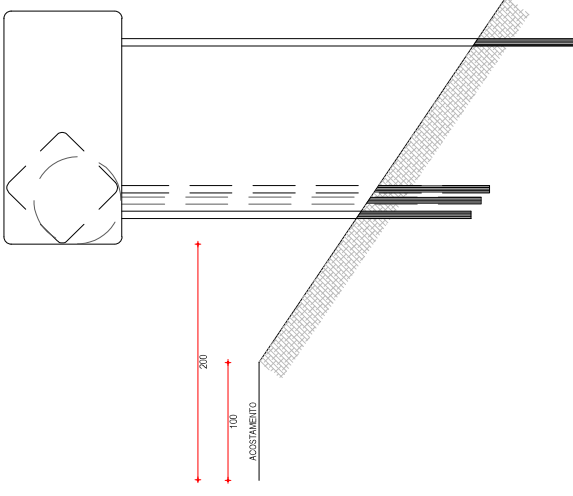

01 DETALHE PLACAS INDICATIVAS EM ATERRIO
ESCALA: SEM

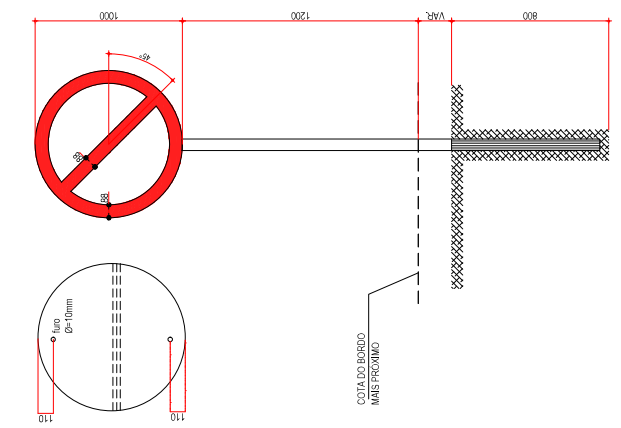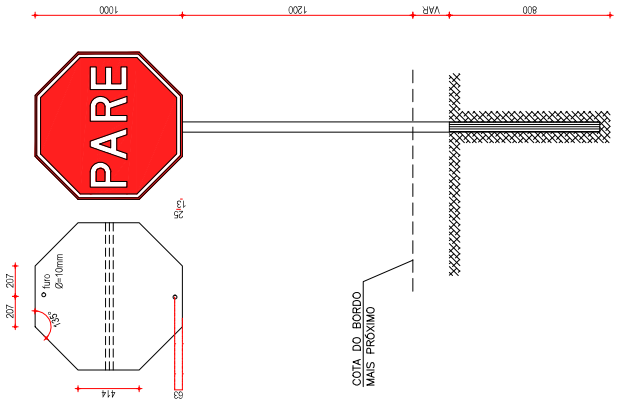

04 DETALHE PLACAS DE REGULAMENTAÇÃO R-3 A R-31
ESCALA: SEM

03 DETALHE PLACA DE REGULAMENTAÇÃO R-01
ESCALA: SEM

